NEW BRANCH BUILDING FOR BANK OF STOCKTON

1376 EAST IT STERRET - IRWY 120 / 108 OAKDALE, CA. APN: 054-011-022

PERMIT SET: 12-10-13



SHADE STRUCTURE/ CARPORT, COVERED DRIVE-THRU AND

PORCHES. ALL UNENCLOSED ROOF AREAS = 2,500 SQ. FT.

TOTAL BANK BUILDING AND COVERED UNENCLOSED ROOF AREAS = 5,940 SQ. FT.

CODE ANALYSIS

SEE CODE ANALYSIS AND NOTES ON SHEET A-001

CODES / STANDARDS ALL WORK SHALL BE IN ACCORDANCE WITH ALL FEDERAL, STATE AND

ALL WORK SHALL COMPLY WITH THE 2010 EDITIONS OF THE

LOCAL BUILDING CODES AND SAFETY ORDINANCES IN EFFECT AT THE

C.B.C., C.M.C., C.P.C., C.E.C., AND PROPERTY MAINTENANCE CODES, , THE 2008 ENERGY STANDARDS AND ALL APPLICABLE

PREMISES SHALL COMPLY WITH TITLE III OF THE AMERICANS WITH DISABILITIES ACT (ADA). COMPLIANCE WILL INCLUDE, BUT NOT BE LIMITED TO, THE DESIGN, CONSTRUCTION AND/OR ALTERATION OF

FIRE SPRINKLER SYSTEM

SEE NOTES ON SHEET A-002

MUST BE AT THE JOB SITE DURING CONSTRUCTION.

SPRINKLER SHOP DRAWINGS SHALL BE SUBMITTED TO LOCAL AUTHORITIES FOR APPROVAL BEFORE ANY INSTALLATION CAN BEGIN. APPROVED DRAWINGS

SCOPE OF WORK


CONSTRUCTION OF NEW 3,440 COMMERCIAL BANK BUILDING FOR THE BANK OF STOCKTON

INCLUDING, BUT NOT LIMITED TO:

- CONCRETE FOUNDATIONS -- EXTERIOR MASONRY WALLS
- -- EXTERIOR WOOD FRAME WALLS - PREFABRICATED WOOD ROOF TRUSSES
- -- CURVED GLULAM ROOF STRUCTURE -- METAL ROOFS
- -- RAISED FLOOR SYSTEM
- -- INTERIOR PARTITION WALLS
- -- CASEWORK AND BUILT-INS -- INTERIOR FINISHES
- -- DOORS AND FRAMES
- -- METAL WINDOWS AND STOREFRONT SYSTEMS -- VIDEO SURVEILLANCE AND SECURITY SYSTEMS
- -- FIRE PROTECTION AND ALARM SYSTEMS -- PLUMBING SYSTEMS AND FIXTURES
- MECHANICAL SYSTEMS, DUCTWORK, EQUIPMENT - ELECTRICAL SYSTEMS, LIGHTING, WIRING, DEVICES
- AND FIXTURES
- -- SITE WORK, DRIVEWAYS, CURBING AND PARKING
- -- EXTERIOR SIGNAGE - LANDSCAPING, SEEDING AND IRRIGATION SYSTEMS
- GRADING AND STORM WATER DETENTION -- UTILITY SERVICES
- -- COVERED ENTRANCES AND PORCHES
- -- COVERED DRIVE-THRU -- COVERED PARKING CANOPY

ALL CONSTRUCTION SHALL BE APPROPRIATE FOR A FIRST CLASS, NEW, MODERN BANK BUILDING

LOCATION MAP

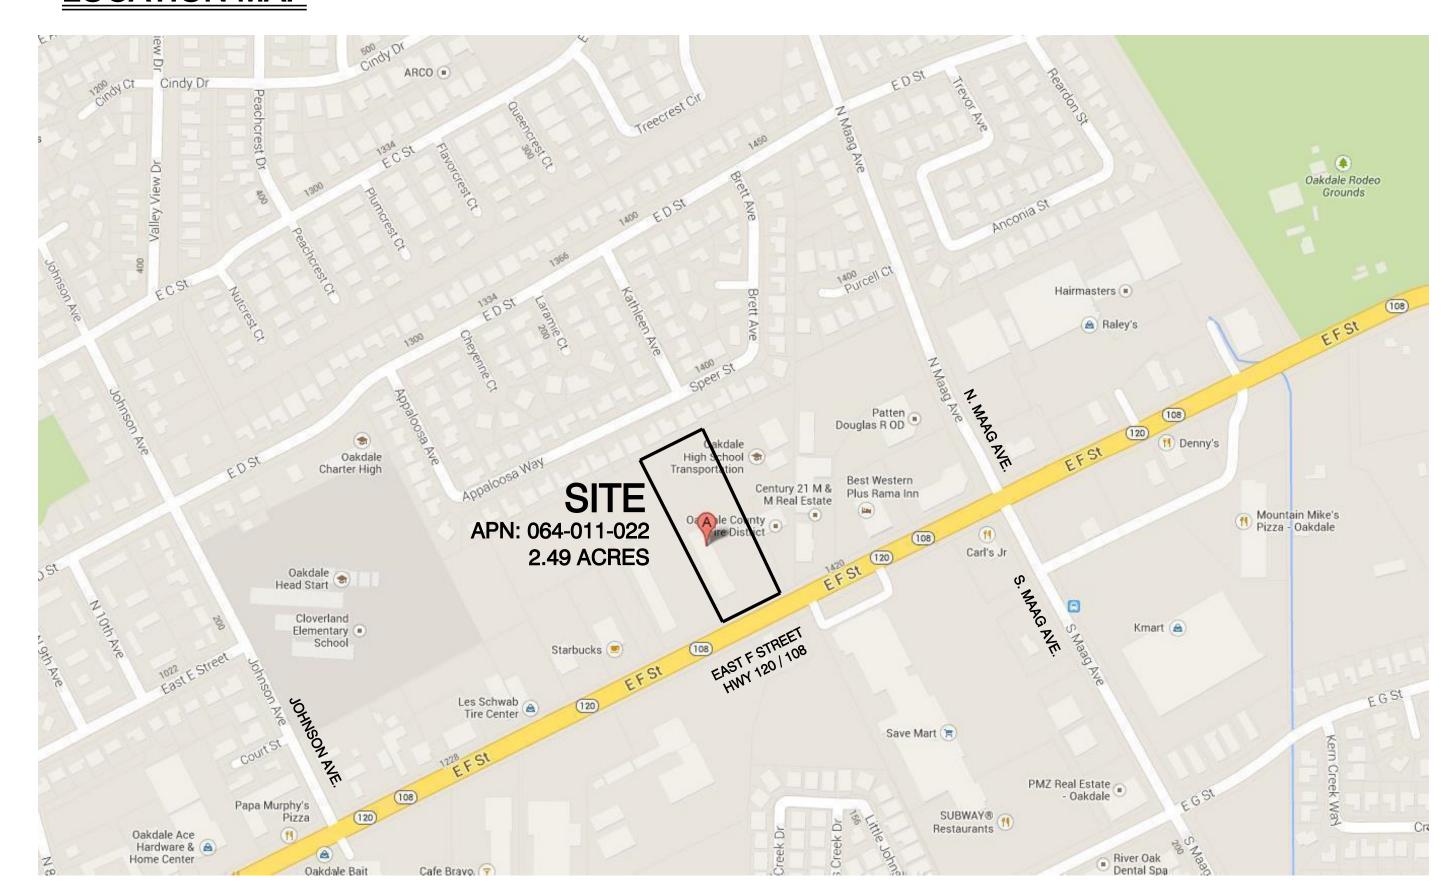



GENERAL CONDITIONS

SCHEDULES ARE MET AND THAT ALL WORK IS DONE IN CONFORMANCE TO MANUFACTURERS. REQUIREMENTS. WORK REQUIRED UNDER THIS CONTRACT SHALL INCLUDE ALL LABOR, MATERIALS UNUSED, UNLESS SPECIFICALLY NOTED, AND BE OF A QUALITY ACCEPTABLE BY INDUSTRY STANDARDS

CONTRACTOR'S PRESENCE: CONTRACTOR SHALL PERSONALLY SUPERVISE AND DIRECT THE WORK OR SHALL KEEP A COMPETENT EMPLOYEE, AUTHORIZED TO RECEIVE INSTRUCTIONS AND ACT ON THE

CONTRACTOR'S BEHALF, CONTINUOUSLY ON SITE DURING WORKING HOURS.

CONTRACTOR REVIEW

CONTRACTOR(S) ACKNOWLEDGES THAT HE HAS THOROUGHLY FAMILIARIZED HIMSELF WITH THE BUILDING SITE CONDITIONS, GRADES, ETC., WITH THE DRAWINGS AND SPECIFICATIONS, WITH THE DELIVERY FACILITIES AND ALL OTHER MATTERS AND CONDITIONS WHICH MAY AFFECT THE OPERATION AND COMPLETION OF THE WORK AND ASSUMES ALL RISKS THEREFROM.

CONTRACTOR(S) SHALL VERIFY CHECK ALL DIMENSIONS, UTILITY LOCATIONS AND CONDITIONS PRIOR TO, AND DURING CONSTRUCTION.

CONTRACT DOCUMENTS / DRAWINGS

THE CONTRACTOR SHALL MAINTAIN A CURRENT AND COMPLETE SET OF CONSTRUCTION DOCUMENTS ON THE JOB SITE DURING ALL PHASES OF CONSTRUCTION FOR USE OF ALL TRADES AND SHALL PROVIDE ALL SUBCONTRACTORS WITH CURRENT CONSTRUCTION DOCUMENTS AS REQUIRED. THE CONTRACTOR, IN ASSUMING RESPONSIBILITY FOR THE WORK INDICATED, SHALL COMPLY WITH THE SPIRIT AS WELL AS WITH THE LETTER IN WHICH THEY WERE DRAWN.

THE CONSTRUCTION DOCUMENTS: ARE PROVIDED TO ILLUSTRATE THE DESIGN AND GENERAL TYPE OF CONSTRUCTION DESIRED AND IMPLY THE FINEST QUALITY OF CONSTRUCTION, MATERIAL AND

DO NOT SCALE DRAWINGS, WRITTEN DIMENSIONS SHALL HAVE PRECEDENCE OVER SCALED DIMENSIONS. CONTRACTOR(S) SHALL VERIFY AND BE MADE RESPONSIBLE FOR ALL DIMENSIONS AND CONDITIONS SHOWN AND A WRITTEN CHANGE ORDER SHALL BE ISSUED BEFORE MAKING ANY CHANGES AT THE

ALL DIMENSIONS ARE TO FACE OF STUD OR FACE OF CONCRETE OR MASONRY AT WALLS OR FACE OF FINISHED SURFACE AT CABINETRY, UNLESS OTHERWISE NOTED.

DETAILS SHOWN ARE TYPICAL. SIMILAR DETAILS APPLY IN SIMILAR CONDITIONS

ERRORS / OMISSIONS / CONFLICTS

ANY ERRORS, OMISSIONS, OR CONFLICTS FOUND IN THE VARIOUS PARTS OF THE CONSTRUCTION DOCUMENTS SHALL BE BROUGHT TO THE ATTENTION OF THE ARCHITECT AND THE OWNER BEFORE

ANY CONFLICTS OR DISCREPANCIES BETWEEN THE DRAWINGS AND SITE CONDITIONS SHALL BE IMMEDIATELY BROUGHT TO THE ATTENTION OF THE ARCHITECT AND THE OWNER BEFORE PROCEEDING WITH THE WORK.

CHANGES

ARCHITECT WILL NOT BE RESPONSIBLE FOR ANY CHANGES IN PLANS, DETAILS, OR SPECIFICATIONS UNLESS APPROVED IN ADVANCE OF CONSTRUCTION.

OWNER COORDINATION

CONTRACTOR MUST COORDINATE CONSTRUCTION WITH BUILDING OWNER'S REPRESENTATIVE. CONTRACTOR(S) TO PROVIDE OWNER 14 DAYS NOTICE AND MEET WITH OWNER'S REPRESENTATIVE FOR A PRECONSTRUCTION MEETING PRIOR TO THE START OF CONSTRUCTION.

JOB SITE / SAFETY

BY ACCEPTING AND USING THESE DRAWINGS, CONTRACTOR(S) AGREES THAT HE SHALL ASSUME SOLE AND COMPLETE RESPONSIBILITY FOR JOB SITE SAFETY CONDITIONS DURING THE COURSE OF CONSTRUCTION OF THIS PROJECT, INCLUDING SAFETY OF ALL PERSONS AND PROPERTY; THAT THIS REQUIREMENT SHALL APPLY CONTINUOUSLY AND NOT BE LIMITED TO NORMAL WORKING HOURS; AND THAT THE CONTRACTOR(S) SHALL DEFEND, INDEMNIFY, AND HOLD THE OWNER AND THE ARCHITECT HARMLESS FROM ANY AND ALL LIABILITY, REAL OR ALLEGED, IN CONNECTION WITH THE PERFORMANCE OF WORK ON THIS PROJECT, EXCEPTING FOR LIABILITY ARISING FROM THE SOLE NEGLIGENCE OF THE OWNER, TENANT, OR THE ARCHITECT.

CONSTRUCTION DEBRIS: THE CONTRACTOR SHALL REMOVE ALL RUBBISH AND WASTE MATERIALS OF ALL SUBCONTRACTORS AND TRADES ON A REGULAR BASIS, AND SHALL EXERCISE STRICT CONTROL OVER JOB CLEANING TO PREVENT ANY DIRT, DEBRIS OR DUST FROM AFFECTING IN ANY WAY, FINISHED AREAS IN OR

MATERIALS AND EQUIPMENT

ALL MATERIALS USED IN THE CONSTRUCTION OF THIS SPACE MUST BE ASBESTOS FREE. ABSOLUTELY NO ASBESTOS CONTAINING BUILDING MATERIALS ARE ALLOWED WITHIN THE DEMISED PREMISES.

IT IS THE RESPONSIBILITY OF THE CONTRACTOR(S), WHEN PREPARING FOR AND PROCEEDING WITH CONSTRUCTION IN THE PREMISES, TO COMPLY WITH ALL REQUIREMENTS OF ALL APPLICABLE LAWS CONCERNING HAZARDOUS SUBSTANCES. THE CONTRACTOR SHALL NOT PERMIT THE INSTALLATION OR USE OF ANY HAZARDOUS SUBSTANCES IN ANY COMPONENT OF THE PREMISES. THE OWNER SHALL NOT PERMIT THE INSTALLATION OR USE OF ANY HAZARDOUS SUBSTANCES IN ANY COMPONENT OF THE PREMISES DURING ITS TENANCY.

CONTRACTOR SHALL SUBMIT MATERIAL SAMPLES AND COLOR BOARD(S) TO OWNER FOR APPROVAL ALL MATERIALS FOR USE ON A PROJECT SHALL BE STORED WITHIN THE PROJECT SITE.

CONTRACTOR SHALL PROTECT NEW MATERIALS AND FINISHES FROM DAMAGE WHICH MAY OCCUR FROM CONSTRUCTION, DEMOLITION, DUST, WATER, FTC., AND SHALL PROVIDE AND MAINTAIN TEMPORARY BARRICADES, CLOSURE WALLS. ETC., AS REQUIRED TO PROTECT THE PUBLIC AS REQUIRED DURING THE PERIOD OF CONSTRUCTION. DAMAGE TO NEW MATERIALS, FINISHES, STRUCTURES, AND EQUIPMENT SHALL BE REPAIRED OR REPLACED.

APPROVED BY THE LOCAL BUREAU OF BUILDING INSPECTION. INSTALL ALL MATERIALS AND EQUIPMENT PER MANUFACTURER'S WRITTEN RECOMMENDATIONS.

CONTRACTOR(S) SHALL BE RESPONSIBLE FOR SUPPLYING ONLY THOSE MATERIALS SPECIFICALLY

ABBREVIATIONS

ABOVE FINISH FLOOR **ALUMINUM ATTENTION** BATHRM. BUILDING **BLOCKING** BLKG. BOARD **CABINETRY CENTER LINE** CEILING CONCRETE MASONRY UNIT

COL. COLUMN CONCRETE CONT. CONTINUOUS **CENTER POINT CERAMIC TILE**

C.T. DIA. DIAMETER DBL. **DOUBLE** DOWN **DRAWINGS** EACH

EXPANSION JOINT ELEVATION ELEV. EQ. EQUAL

EXISTING **EXTERIOR**

FURNISHED BY OWNER F.O.F. FACE OF FINISH F.O.S. FACE OF STRUCTURE FINISH **FLOOR GAUGE**

GALVANIZED GLASS GLUE LAMINATED GYPSUM WALL BOARD **HARDWARE** H.M. **HOLLOW METAL**

HIGH POINT HORIZONTAL HEIGHT INSIDE DIMENSION J.B. JUNCTION BOX JOINT

LAMINATED **LAVATORY** LOW POINT **MECHANICAL** MINIMUM

MOISTURE RESISTANT **METAL** NOT IN CONTRACT **NOMINAL** NOT TO SCALE NTS

ON CENTER OUTSIDE DIMENSION OVERHEAD OPENING **OPPOSITE**

PROPERTY LINE PLASTIC LAMINATE PLAS. PLASTER PLYWD. **PLYWOOD**

PREFAB PREFABRICATED PT. **POINT** PTD. **PAINTED** QUANTITY QTY. RADIUS RAD. R.D. **ROOF DRAIN** REF. REFERENCE REG.

REGISTER REINF. REINFORCING REQUIRED RET. RETURN ROOM RIGHT OF WAY RAIN WATER LEADER R.W.L.

SCHEDULE SCHED. SIMILAR SIM. SQ. SQUARE STAINLESS STEEL S.S. STANDARD STD. STEEL STL SUSPENDED SUSP.

T.B.D.

T.O. TOP OF TOP OF PARAPET T.O.P. T.O.C. TOP OF CONCRETE T.O.W. TOP OF WALL THK. THICK UNLESS NOTED OTHERWISE

VAR. VARIES VCT VINYL COMPOSITE TILE **VERIFY IN FIELD** V.I.F. W.C. WATER CLOSET WOOD

TO BE DETERMINED

PROJECT DIRECTORY

Miner San Joaquin Building Corp. P.O. Box 1110 Stockton, CA 95201

DESIGN+BUILD CONTRACTOR: Lennen Construction, Inc. 1136 West Fremont Street Stockton, CA 95203 Jack Lennen CL #798968 209.933.9000

PLANNING CONSULTANT: Price Consulting Services Gary Price, Principal 530.218.1059

DESIGN+BUILD ARCHITECT Thomas Roman Architect 530.205.8750 Architect License C28022 Lennen Construction Design + Build 1136 West Fremont Street Stockton, CA 95203

DESIGN+BUILD CIVIL ENGINEER Lincoln and Long Engineering 530.273.0503 Lennen Construction, Inc. 1136 West Fremont Street Stockton, CA 95203

DESIGN+BUILD STRUCTURAL ENGINEER: Lincoln and Long Engineering 530.273.0503 Lennen Construction, Inc. 1136 West Fremont Street Stockton, CA 95203

DESIGN+BUILD LANDSCAPE ARCHITECT: Karen Clausen, Landscape Architect 530.885.8196 Lennen Construction Design + Build 1136 West Fremont Street Stockton, CA 95203

DESIGN+BUILD ELECTRICAL: Kirkes Electric Inc. Larry Nathanson, VP 999 North Golden State Blvd Turlock, CA 95380 209.634.9301 Lic# 306333

DESIGN+BUILD HVAC: Nielson Mechanical, Inc Lou Flores 4987 Noonan Lane Fairfield, CA 94533 707.437.5020 Lic# 725457

DESIGN+BUILD PLUMBING M. Santos & Sons Const., Inc Tony Santos 2724 Shoemaker Avenue Modesto, CA 95358 209.523.3266

M. Santos & Sons Const., Inc. Tony Santos 2724 Shoemaker Avenue Modesto, CA 95358 209.523.3266 PRE-FABRICATED WOOD TRUSS DESIGN:

DESIGN+BUILD FIRE SPRINKLERS:

Stockton Truss Travis Nixon 4408 E. Fremont Street Stockton, CA 95215 209.464.7358

SHEET INDEX / DOCUMENTS

COVER SHEET

LINCOLN AND LONG ENGINEERING C1: COVER SHEET C2: GRADING PLAN

C3: UTILITY PLAN C4: EROSION CONTROL PLAN C5: CAL-TRANS DETAILS **C6: CITY OF OAKDALE STANDARD DETAILS** C7: CITY OF OAKDALE STANDARD DETAILS

C8: STANDARD DETAILS LANDSCAPE PLANS J.K. CLAUSEN, INC. L1.0: LAYOUT PLAN

L2.0: PLANTING PLAN L2.1: PLANTING SPECIFICATIONS L2.2: TREE SHADE PLAN

L3.0: IRRIGATION PLAN AND LEGEND L3.1: IRRIGATION SPECIFICATIONS

THOMAS ROMAN ARCHITECT ARCHITECTURAL PLANS A 001: CODE ANALYSIS / EGRESS PLAN A 002: GENERAL NOTES / ACCESSIBILITY

A 101: UNDER-FLOOR PLAN A 102: FLOOR PLAN A 103: LOFT / CLERESTORY PLAN A 104: ROOF PLAN A 105: REFLECTED CEILING PLAN - LOWER A 106: REFLECTED CEILING PLAN - UPPER

A 210: ELEVATIONS A 202: ELEVATIONS

A 301: BUILDING SECTIONS

A: 401: WALL SECTIONS A: 402: WALL SECTIONS A: 403: WALL SECTIONS A: 404: WALL SECTIONS A: 405: WALL SECTIONS

A: 406: WALL SECTIONS A: 407: WALL SECTIONS A: 408: WALL SECTIONS A: 409: WALL SECTIONS A: 410: WALL SECTIONS

A 501: MASONRY / MISC. DETAILS A 502: STUCCO / MISC. DETAILS A 503: ROOFING / MISC. DETAILS A 504: MISCELLANEOUS DETAILS A 505: PARTITION TYPES / MISC. DETAILS A 506: RAISED FLOOR / MISC. DETAILS

A 601: DOORS AND WINDOWS A 602: FINISHES / INTERIORS A 603: CABINETS / INTERIORS A 701: SITE ITEMS

LINCOLN AND LONG ENGINEERING S1: FOUNDATION PLAN S2: SHEAR PLAN

S3: INNER TRELLIS FRAMING PLAN S4: OUTER CVR'D PORCH / TRELLIS FRAMING PLAN S5: ROOF FRAMING PLAN S6: CLERESTORY ROOF FRAMING PLAN S7: PARKING FRAMING / FOUNDATION PLAN

SN1: STRUCTURAL NOTES SD1: STRUCTURAL DETAILS **SD2: STRUCTURAL DETAILS**

SD3: STRUCTURAL DETAILS

<STRUCTURAL CALCULATIONS> LINCOLN AND LONG ENGINEERING

<TRUSS LAYOUT / ENGINEERING> STOCKTON TRUSS

NIELSON MECHANICAL

MECHANICAL PLANS M 101: UNDER-FLOOR MECHANICAL PLAN M 102: MECHANICAL FLOOR PLAN

P-1: SEWER AND VENT PLAN

P-2: WATER AND GAS PLAN

M 104: MECHANICAL ROOF PLAN M 105: HVAC EQUIPMENT SCHEDULES M 106: TITLE 24 **ELECTRICAL PLANS** KIRKES ELECTRIC INC.

E-100: TITLE 24 / SCHEDULES E-200: ELECTRICAL POWER PLAN E-300: ELECTRICAL CEILING PLAN E-400: ELECTRICAL SITE PLAN E-500: ELECTRICAL ROOF AND UNDER-FLOOR PLANS

PLUMBING PLANS M. SANTOS AND SONS, INC. Sacramento, CA 95811 1 Bank St., PMB 191 rass Valley, CA 95945


CONSTRUCTION

530.205.8750

DESIGN BUILD **LICENSE #798968 STOCKTON:** 209.933.9000

PALM DESERT: 760.636.5992 760.636.5996 FAX

209.933.1900 FAX

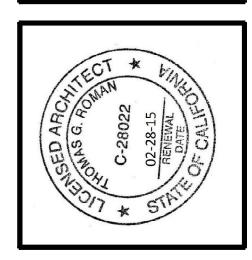


FINAL DRAWINGS PERMIT SET 12-10-13

ALL FIELD CHANGES TO APPROVED SET OF PLANS SHALL BE FIRST APPROVED BY THE BUILDING DEPARTMENT. FAILURE TO PROVIDE CHANGES TO THE BUILDING DEPARTMENT WILL BE

CAUSE FOR THE DEPARTMENT TO ISSUE A STOP WORK NOTICE. CADD FOLDER BOS OAKDALE CADD FILE

DRAWN BY

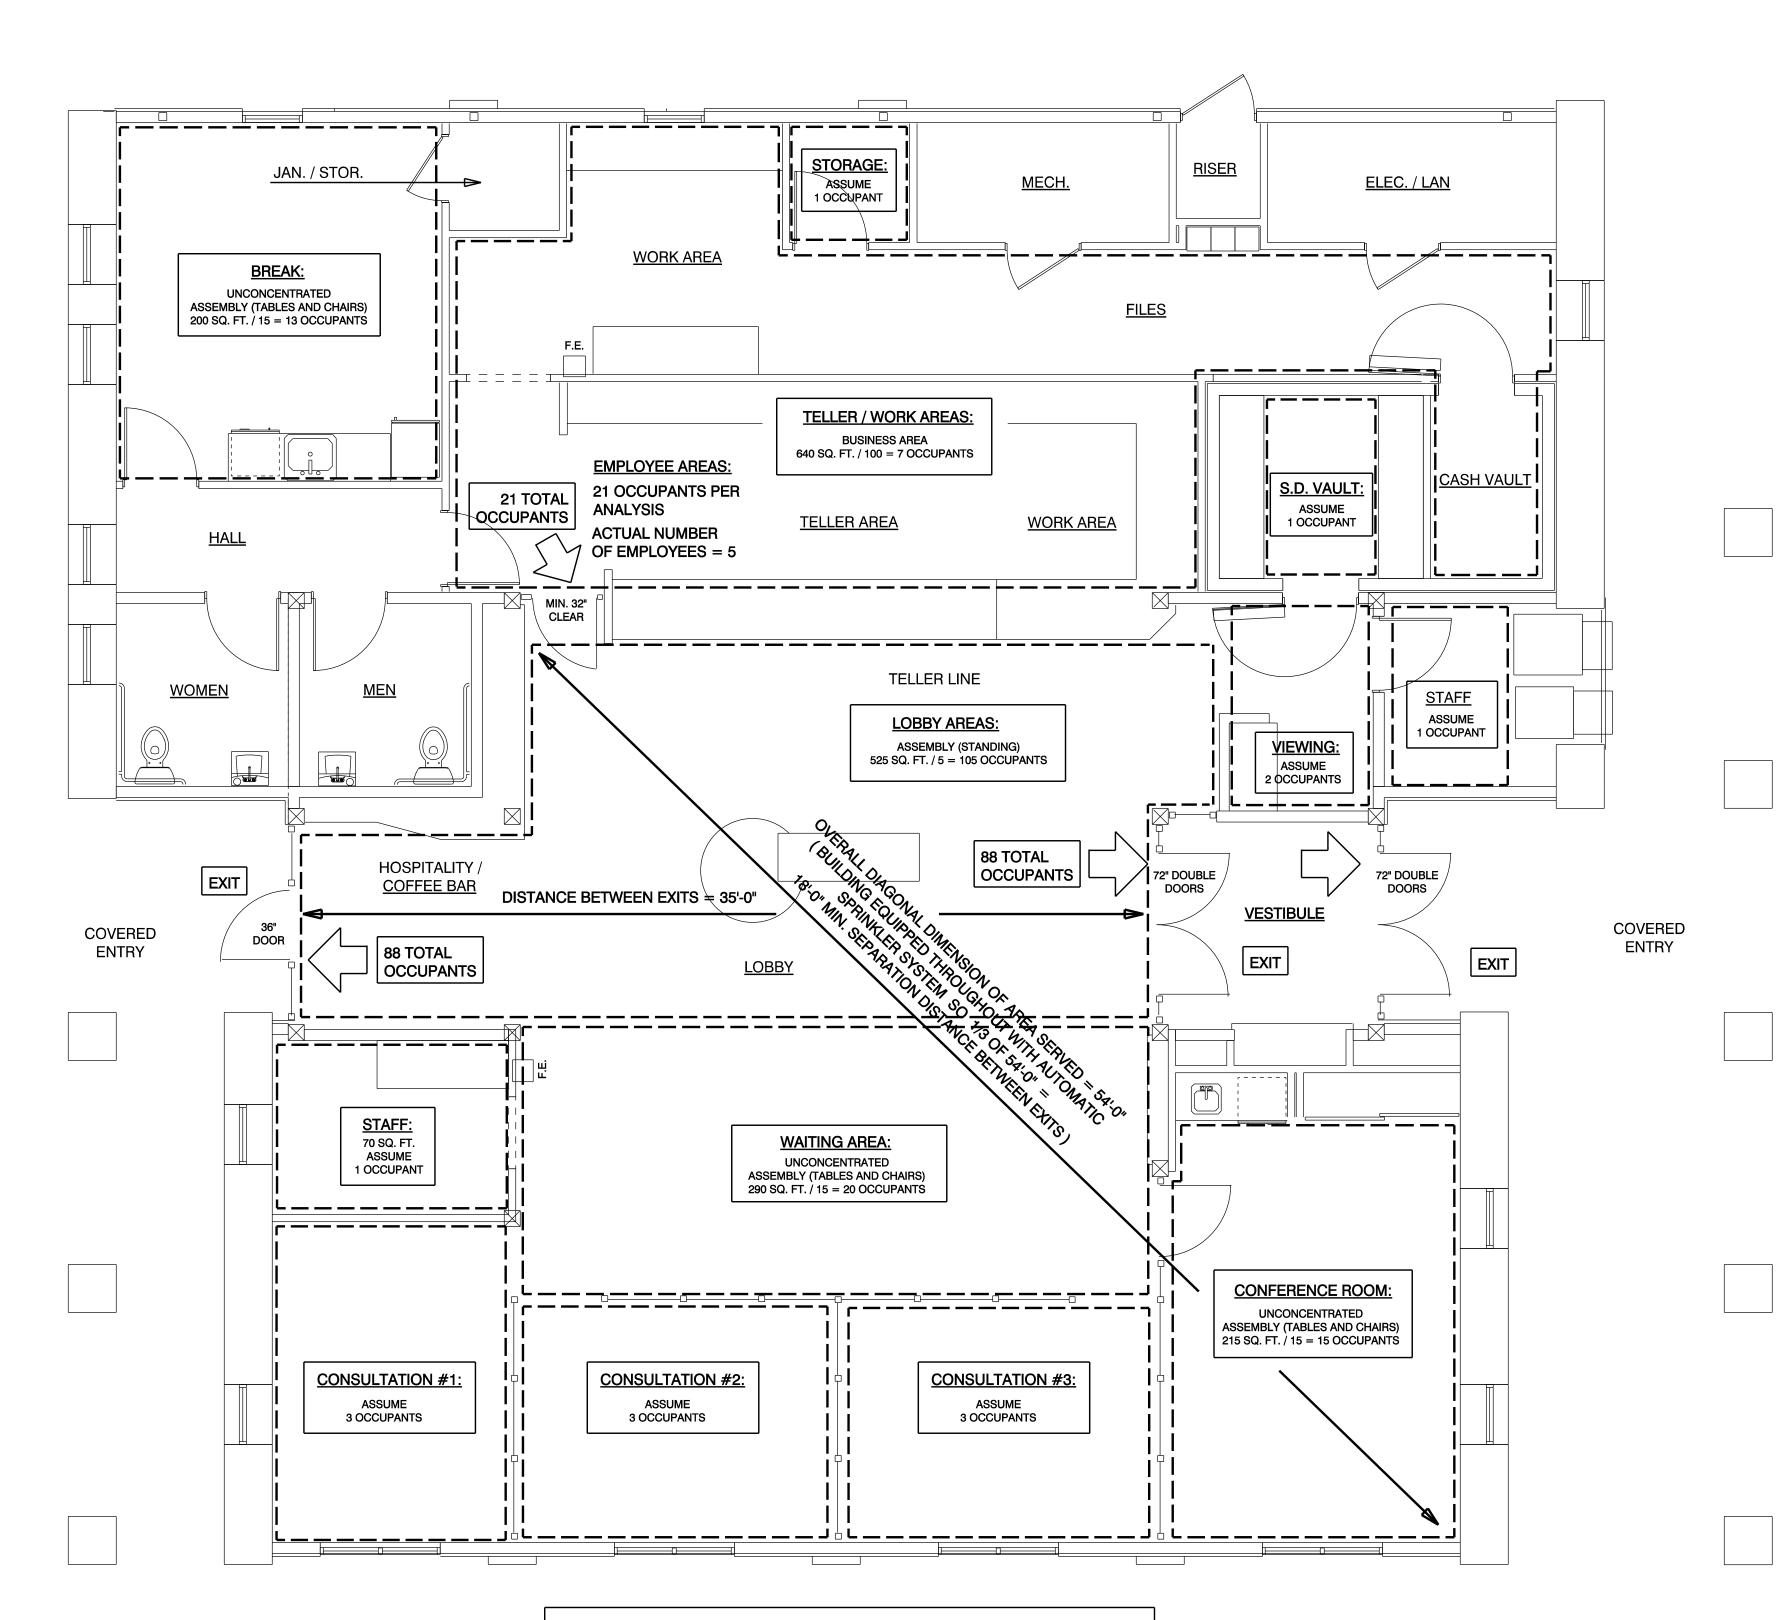

TOTAL OCCUPANT LOAD = 175 OCCUPANTS

EGRESS / OCCUPANCY LOAD ANALYSIS

SCALE: 1/4" = 1'-0"

PROJECT
NORTH



C.B.C. ANALYSIS

ONE STORY BANK BUILDING = 3,440 SQ. FT.

BUILDING HEIGHT APPROX. 24 FT.

BANK BUILDING SHALL BE FULLY SPRINKLERED.

SHADE STRUCTURE/ CARPORT, COVERED DRIVE-THRU AND PORCHES. ALL UNENCLOSED ROOF AREAS = 2,500 SQ. FT.

TOTAL BANK BUILDING AND COVERED UNENCLOSED ROOF AREAS = 5,940 SQ. FT.

OCCUPANCY GROUPS

BANK AREA TO BE CLASSIFIED AS OCCUPANCY GROUP B - BUSINESS

304.1 BUSINESS GROUP B. BUSINESS GROUP B OCCUPANCY INCLUDES, AMONG OTHERS, THE USE OF A BUILDING OR STRUCTURE, OR A PORTION THEREOF, FOR OFFICE, PROFESSIONAL OR SERVICE-TYPE TRANSACTIONS, INCLUDING STORAGE OF RECORDS AND ACCOUNTS. BUSINESS OCCUPANCIES SHALL INCLUDE, BUT NOT BE LIMITED TO, THE FOLLOWING:

BANKS

COVERED PARKING AREA TO BE CLASSIFIED AS OCCUPANCY GROUP U -UTILITY (CARPORT)

312.1 UTILITY AND MISCELLANEOUS GROUP U. BUILDINGS AND STRUCTURES OF AN ACCESSORY CHARACTER AND MISCELLANEOUS STRUCTURES NOT CLASSIFIED IN ANY SPECIFIC OCCUPANCY SHALL BE CONSTRUCTED, EQUIPPED AND MAINTAINED TO CONFORM TO THE REQUIREMENTS OF THIS CODE COMMENSURATE WITH THE FIRE AND LIFE HAZARD INCIDENTAL

TO THEIR OCCUPANCY. GROUP U SHALL INCLUDE, BUT NOT BE

CARPORTS

.....

LIMITED TO, THE FOLLOWING:

SPECIAL PROVISIONS

SHADE STRUCTURE ROOF AREA IS APPROX. 1,200 SQ. FT. DRIVE-THRU TELLER CANOPY ROOF AREA IS APPROX. 400 SQ. FT.

BOTH STRUCTURES COMBINED ARE UNDER 3,000 SQ. FT.

SHADE STRUCTURE AND DRIVE-THRU CANOPIES ARE TO CLASSIFIED AS GROUP U, NOT AS PARKING GARAGE OR GROUP S.

406.1.2 AREA INCREASE. GROUP U OCCUPANCIES USED FOR THE STORAGE OF PRIVATE OR PLEASURE-TYPE MOTOR VEHICLES WHERE NO REPAIR WORK IS COMPLETED OR FUEL IS DISPENSED ARE PERMITTED TO BE 3,000 SQUARE FEET...

MIXED USE AND OCCUPANCY

BANK AREAS AND COVERED PARKING AREAS DO NOT REQUIRE FIRE-RATED SEPARATION.

> **508.3 NONSEPARATED OCCUPANCIES**. BUILDINGS OR PORTIONS OF BUILDINGS THAT COMPLY WITH THE PROVISIONS OF THIS SECTION SHALL BE CONSIDERED AS NONSEPARATED OCCUPANCIES.

508.3.1 OCCUPANCY CLASSIFICATION. NONSEPARATED OCCUPANCIES SHALL BE INDIVIDUALLY CLASSIFIED IN ACCORDANCE WITH SECTION 302.1. THE REQUIREMENTS OF THIS CODE SHALL APPLY TO EACH PORTION OF THE BUILDING BASED ON THE OCCUPANCY CLASSIFICATION OF THAT SPACE EXCEPT THAT THE MOST RESTRICTIVE APPLICABLE PROVISIONS OF SECTION 403 AND CHAPTER 9 SHALL APPLY TO THE BUILDING OR PORTION THEREOF IN WHICH THE NONSEPARATED OCCUPANCIES ARE LOCATED.

508.3.2 ALLOWABLE BUILDING AREA AND HEIGHT. THE ALLOWABLE BUILDING AREA AND HEIGHT OF THE BUILDING OR PORTION THEREOF SHALL BE BASED ON THE MOST RESTRICTIVE ALLOWANCES FOR THE OCCUPANCY GROUPS UNDER CONSIDERATION FOR THE TYPE OF CONSTRUCTION OF THE BUILDING IN ACCORDANCE WITH SECTION 503.1.

508.3.3 SEPARATION. NO SEPARATION IS REQUIRED BETWEEN NONSEPARATED OCCUPANCIES.

ACCESSORY AREAS DO NOT REQUIRE FIRE-RATED SEPARATION.

STORAGE ROOM(S) LESS THAN 100 SQ. FT.: OCCUPANCY GROUP S-2 -

MECH. AND ELECTRICAL ROOM(S): OCCUPANCY GROUP U - UTILITY AND MISC.

508.2 ACCESSORY OCCUPANCIES. ACCESSORY OCCUPANCIES ARE THOSE OCCUPANCIES THAT ARE ANCILLARY TO THE MAIN OCCUPANCY OF THE BUILDING OR PORTION THEREOF.

508.2.1 AREA LIMITATIONS. AGGREGATE ACCESSORY OCCUPANCIES SHALL NOT OCCUPY MORE THAN 10 PERCENT OF THE BUILDING AREA OF THE STORY IN WHICH THEY ARE LOCATED

508.2.4 SEPARATION OF OCCUPANCIES. NO SEPARATION IS REQUIRED BETWEEN ACCESSORY OCCUPANCIES AND THE MAIN OCCUPANCY.

ASSEMBLY AREAS DO NOT REQUIRE FIRE-RATED SEPARATION.

CONFERENCE ROOM AND BREAK ROOM: OCCUPANCY GROUP B -

303.1 EXCEPTION 2. A ROOM OR SPACE USED FOR ASSEMBLY PURPOSES WITH AN OCCUPANT LOAD OF LESS THAN 50 PERSONS AND ACCESSORY TO ANOTHER OCCUPANCY SHALL BE CLASSIFIED AS A GROUP B OCCUPANCY OR AS PART OF THAT OCCUPANCY.

303.1 EXCEPTION 3. A ROOM OR SPACE USED FOR ASSEMBLY PURPOSES THAT IS LESS THAN 750 SQUARE FEET IN AREA AND ACCESSORY TO ANOTHER OCCUPANCY SHALL BE CLASSIFIED AS A GROUP B OCCUPANCY OR AS PART OF THAT OCCUPANCY.

TYPE OF CONSTRUCTION / ALLOWABLE AREA

PROJECT IS ONE STORY. BANK BUILDING IS APPROX. 3,440 SQ. FT.

PROJECT IS APPROX. 5,940 SQ. FT. (INCLUDING BOTH THE BANK BUILDING AND THE UNENCLOSED COVERED PARKING AND UNENCLOSED COVERED

BUILDING HEIGHT IS APPROX. 24'

PER TABLE 503 - GROUP B AND GROUP U - GROUP U IS THE MOST RESTRICTIVE, SO WE WILL USE THE ALLOWABLE AREA FOR GROUP U.

TYPE V-B CONSTRUCTION AND GROUP U OCCUPANCY = 5,500 SQ. FT. ALLOWABLE AREA.

BUILDING AREA INCREASE DUE TO SECTION 506.2 FRONTAGE INCREASE

MINIMUM CLEAR WIDTH OF 30 FT.

THE SOUTH SIDE OF THE PROJECT TO BE LOCATED ALONG F STREET (HWY 120 / 108).

THE EAST SIDE OF THE PROJECT TO BE LOCATED ALONG A DEDICATED ACCESS EASEMENT OVER 50

THEREFORE WE WILL ASSUME 50% OF THE PROJECT TO BE LOCATED ALONG A PUBLIC WAY WITH A

AREA INCREASE DUE TO FRONTAGE (EQUATION 5-1):

INCREASE = [160' / 320' - 0.25] 30' / 30 INCREASE = [0.5 - 0.25] X 1 INCREASE = .25 X 1INCREASE = 0.25

ALLOWABLE AREA FOR GROUP U, INCLUDING 25% INCREASE DUE TO SECTION 506.2, = 6,875 SQ. FT.

CONSTRUCTION TO BE TYPE II-B NON-COMBUSTIBLE CONSTRUCTION

FT. IN WIDTH.

NON-SEPARATED OCCUPANCIES ALLOWABLE: GROUP B - BANK AND GROUP U - CARPORT

SPRINKLER SYSTEM

SECTION 903 - AUTOMATIC SPRINKLER SYSTEMS

AUTOMATIC SPRINKLER SYSTEMS ARE NOT REQUIRED FOR GROUP B OCCUPANCY.

AUTOMATIC SPRINKLER SYSTEMS ARE NOT REQUIRED FOR GROUP U OCCUPANCY.

ALTHOUGH NOT REQUIRED BY THE CBC, THE BANK BUILDING SHALL BE FULLY SPRINKLERED.

CONSTRUCTION MATERIALS

TYPE V-B CONSTRUCTION WITH GLULAMS AND/OR HEAVY TIMBER AT ROOF FRAMING

TABLE 601: TYPE V-B CONSTRUCTION REQUIREMENTS

STRUCTURAL FRAME: NO FIRE RATED REQUIREMENT **BEARING WALLS INTERIOR:** NO FIRE RATED REQUIREMENT BEARING WALLS EXTERIOR: NO FIRE RATED REQUIREMENT NON-BEARING WALLS: NO FIRE RATED REQUIREMENT NO FIRE RATED REQUIREMENT FLOOR CONSTRUCTION: ROOF CONSTRUCTION: NO FIRE RATED REQUIREMENT

FIRE SEPARATION DISTANCE - EXTERIOR WALLS

BUILDING IS LOCATED ON LOT SUCH THAT ALL EXTERIOR WALLS ARE MORE THAN 30 FEET AWAY FROM PROPERTY LINES AND OTHER STRUCTURES, THEREFORE THERE IS NO FIRE-RESISTANCE RATED EXTERIOR WALL REQUIREMENTS

TABLE 602: FIRE RESISTANCE RATING REQUIREMENTS BASED

ON FIRE SEPARATION DISTANCE FIRE SEPARATION DISTANCE IS GREATER THAN 10 FEET WITH TYPE V-B FOR GROUPS B AND U

SO **NO FIRE RATED REQUIREMENT** FIRE SEPARATION DISTANCE - OPENING PROTECTION

BUILDING IS LOCATED ON LOT SUCH THAT ALL EXTERIOR WALLS ARE MORE THAN 30 FEET AWAY FROM PROPERTY LINES AND OTHER STRUCTURES, THEREFORE THERE IS NO LIMITS OR PROTECTION REQUIREMENTS FOR OPENINGS

TABLE 705.8: FIRE RESISTANCE RATING REQUIREMENTS BASED ON FIRE SEPARATION DISTANCE

FIRE SEPARATION DISTANCE IS GREATER THAN 30 FEET

SO NO LIMIT TO UNPROTECTED OPENINGS

CONCEALED SPACES - FLOOR

THE BUILDING SHALL BE PROVIDED WITH A RAISED FLOOR SYSTEM, WHICH CREATES A "CONCEALED SPACE" WITHIN THE FLOOR-CEILING ASSEMBLY.

DRAFTSTOPPING OF CONCEALED RAISED FLOOR AREAS IS NOT REQUIRED

DUE TO AUTOMATIC SPRINKLER SYSTEM.

717.3 DRAFTSTOPPING IN FLOORS. IN COMBUSTIBLE CONSTRUCTION, DRAFTSTOPPING SHALL BE INSTALLED TO SUBDIVIDE FLOOR/CEILING ASSEMBLIES

> **EXCEPTIONS:....** DRAFTSTOPPING IS NOT REQUIRED IN BUILDINGS EQUIPPED THROUGHOUT WITH AN **AUTOMATIC SPRINKLER SYSTEM ...**

CONCEALED SPACES - ATTIC

NO SPECIAL ATTIC DRAFT-STOPPING REQUIREMENTS ARE REQUIRED

DUE TO AUTOMATIC SPRINKLER SYSTEM.

717.4.3 DRAFTSTOPPING SHALL BE INSTALLED IN *ATTICS* AND CONCEALED ROOF SPACES, SUCH THAT ANY HORIZONTAL AREA DOES NOT EXCEED 3,000 SQUARE FEET.

EXCEPTIONS: DRAFTSTOPPING IS NOT REQUIRED IN BUILDINGS EQUIPPED THROUGHOUT WITH AN **AUTOMATIC SPRINKLER SYSTEM ...**

THOMAS ROMAN Architecture TR-Architecture.com


809 S St., PMB 362 Sacramento, CA 95811 11 Bank St., PMB 191 Grass Valley, CA 95945 tom@tr-architecture.com 530.205.8750

CONSTRUCTION DESIGN BUILD **LICENSE #798968**

209.933.1900 FAX <u>PALM DESERT:</u> 760.636.5992 760.636.5996 FAX

STOCKTON:

209.933.9000

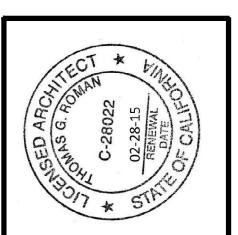

FINAL DRAWINGS

PERMIT SET 12-10-13

ALL FIELD CHANGES TO APPROVED SET OF PLANS SHALL BE FIRST APPROVED BY THE BUILDING DEPARTMENT. FAILURE TO PROVIDE CHANGES TO THE BUILDING DEPARTMENT WILL BE CAUSE FOR THE DEPARTMENT TO

ISSUE A STOP WORK NOTICE. CADD FOLDER BOS OAKDALE

DRAWN BY CODE ANALYSIS **EGRESS PLAN**

PROVIDE AT ALL INTERCONNECTIONS BETWEEN CONCEALED VERTICAL AND HORIZONTAL SPACES SUCH AS OCCUR AT SOFFITS, DROP CEILINGS AND COVE

PROVIDE AT OPENINGS AROUND VENTS, PIPES, DUCTS, AND SIMILAR OPENINGS WHICH AFFORD A PASSAGE FOR FIRE AT CEILING AND FLOOR LEVELS, WITH NONCOMBUSTIBLE MATERIALS.

<u>FINISHES</u>

MOISTURE RESISTANT G.W.B. (GREENBOARD) SHALL BE PROVIDED ON WALLS AT BATHROOMS, JANITOR CLOSET, KITCHENS AND AREAS SUBJECT TO

WATER-RESISTANT GYPSUM BACKING BOARD. GYPSUM BOARD USED AS THE BASE OR BACKER FOR ADHESIVE APPLICATION OF CERAMIC TILE OR OTHER REQUIRED NONABSORBENT FINISH MATERIAL SHALL CONFORM TO ASTM C 1396. C 1178 OR C 1278. USE OF WATER-RESISTANT GYPSUM BACKING BOARD SHALL BE PERMITTED ON CEILINGS WHERE FRAMING SPACING DOES NOT EXCEED 12 INCHES (305 MM) ON CENTER FOR 1/2-INCH-THICK (12.7 MM) OR 16 INCHES (406 MM) FOR 5/8-INCH-THICK (16 MM) GYPSUM BOARD. WATER-RESISTANT GYPSUM BOARD SHALL NOT BE INSTALLED OVER A CLASS I OR II VAPOR RETARDER IN A SHOWER OR TUB COMPARTMENT, CUT OR EXPOSED EDGES, INCLUDING THOSE AT WALL INTERSECTIONS, SHALL BE SEALED AS RECOMMENDED BY THE MANUFACTURER.


GREENBOARD SHALL NOT BE USED IN AREAS SUBJECTED TO DIRECT WATER EXPOSURE OR HIGH HUMIDITY. TILE BACKER BOARD SHALL BE USED AT ALL AREAS SUBJECTED TO DIRECT WATER EXPOSURE OR HUMIDITY.

SOUND INSULATION

PROVIDE SOUND INSULATION IN ALL WALLS.

WOOD FRAMING / WALL CONSTRUCTION

SEISMIC WALL BRACING AS PER STRUCTURAL PLANS AND NOTES. **NOTCHING AND BORING STUDS:**

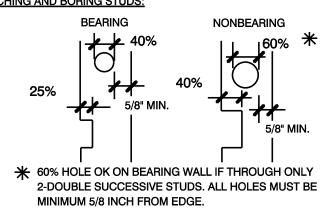

GLULAM BEAMS:

GLULAM BEAM INSPECTION CERTIFICATES SHALL BE SUBMITTED TO THE FIELD INSPECTOR PRIOR TO COMPLETION OF FRAME INSPECTION FOR ALL GLULAM

WINDOWS, GLASS AND GLAZING

ALL GLAZING IN GLASS DOORS AND SIDELIGHTS, SHALL BE OF SAFETY GLAZING MATERIALS (TEMPERED OR LAMINATED SAFETY GLASS). GLAZING WITHIN A 24" ARC OF THE VERTICAL EDGE OF A DOOR IN THE CLOSED POSITION, AND WHICH IS WITHIN 60" OF THE WALKING SURFACE TO BE SAFETY GLAZED.

ALL GLAZING IN DOORS AND IN WINDOWS SHALL BE DUAL GLAZING PER THE ENERGY CALCULATIONS.

SEE ALSO SITE PLANS

FILL SLOPES STEEPER THAN 2 HORIZONTAL TO 1 VERTICAL SHALL BE JUSTIFIED BY SOILS REPORTS OR ENGINEERING DATA. ALL BUILDING PADS NEED TO BE GRADED WITH A 2% SLOPE AWAY FROM THE

BUILDING WRAP

AT THE SLAB JUNCTION

PUSH BAR

EXIT DEVICE

LETTERING

GRADE II BRAILLE

1/4" THICK, UNISEX TOILET

ROOM A.D.A. WALL SIGNAGE

UNISEX

SEE DETAIL

ABOVE

RAISED 1/32"

ACCEPTABLE

DOOR HARDWARE

. UPPERCAS**È** LETTERS

RESTROOM SIGNAGE

LETTERING

TO QUALIFY FOR ENERGY COMPLIANCE CREDIT. AN AIR-RETARDING WRAP MUST BE TESTED AND LABELED BY THE MANUFACTURER TO COMPLY WITH ASTM E 1677-95 (2000). STANDARD SPECIFICATION FOR AN AIR RETARDER (a) MATERIAL OR SYSTEM FOR LOW-RISE FRAMED BUILDING WALLS, AND HAVE A MINIMUM PERM RATING OF 10. INSULATING SHEATHING AND BUILDING PAPER DO NOT QUALIFY AS AIR-RETARDING WRAPS. THE AIR RETARDING WRAP MUST BE INSTALLED PER THE MANUFACTURER'S SPECIFICATIONS. IN PARTICULAR, IT MUST MEET THE FOLLOWING INSTALLATION REQUIREMENTS: - THE AIR-RETARDING WRAP MUST BE INSTALLED CONTINUOUSLY - ALL TEARS OR BREAKS MUST BE REPAIRED WITH MANUFACTURER APPROVED TAPE

- ALL HORIZONTAL SEAMS MUST BE LAPPED IN A SHINGLE-LIKE MANNER AND TAPED - ALL VERTICAL SEAMS MUST BE LAPPED - ALL WINDOWS AND PENETRATIONS MUST BE TAPED OR CAULKED THE AIR-RETARDING WRAP MUST BE TAPED OR OTHERWISE SEALED

GENERAL CONSTRUCTION REQUIREMENTS

SEE ALSO STRUCTURAL DRAWINGS WOOD SUPPORTS EMBEDDED IN THE GROUND OR EMBEDDED IN CONCRETE BELOW GRADE MUST BE PRESSURE TREATED AND RATED FOR DIRECT

PLATES, SILLS AND SLEEPERS NEED TO BE NATURALLY DURABLE OR PRESSURE

GIRDERS ENTERING MASONRY OR CONCRETE WALLS NEED A 1/2" AIR SPACE ON THE TOP, SIDES AND END.

THE PORTIONS OF GLUE-LAMINATED TIMBERS THAT FORM THE STRUCTURAL SUPPORTS OF A BUILDING OR OTHER STRUCTURE AND ARE EXPOSED TO WEATHER AND NOT FULLY PROTECTED FROM MOISTURE BY ROOF, EAVE OR SIMILAR COVERING SHALL BE PRESSURE TREATED WITH PRESERVATIVE OR BE MANUFACTURED FROM NATURALLY DURABLE OR PRESERVATIVE-TREATED

CONNECTIONS FOR WOOD MEMBERS SUCH AS POST AND BEAM/GIRDER CONNECTIONS NEED TO HAVE A POSITIVE CONNECTION SUCH AS A POST CAP OR PLYWOOD GUSSET.

FASTENERS FOR PRESERVATIVE-TREATED AND FIRE-RETARDANT TREATED WOOD SHALL BE OF HOT DIPPED ZINC-COATED GALVANIZED STEEL, STAINLESS STEEL, SILICON BRONZE OR COPPER.

FOUNDATION

SEE ALSO STRUCTURAL DRAWINGS

CONCRETE SLAB FOUNDATIONS SHALL HAVE A VAPOR RETARDER IN ACCORDANCE WITH THE CALIFORNIA BUILDING CODE, CCR, TITLE 24, PART 2,

A CAPILLARY BREAK SHALL BE INSTALLED. PROVIDE A MINIMUM 4-INCH THICK BASE OF 1/2 INCH OR LARGER CLEAN AGGREGATE SHALL BE PROVIDED WITH A VAPOR BARRIER IN DIRECT CONTACT WITH CONCRETE

PROVIDE A CONCRETE MIX DESIGN WHICH WILL ADDRESS BLEEDING. SHRINKAGE, AND CURLING. FOLLOW RECOMMENDATIONS OF THE AMERICAN CONCRETE INSTITUTE, ACI 302.2R-06 ALL STUMPS AND ROOTS NEED TO BE REMOVED TO A DEPTH OF 12" BELOW

THE SURFACE IN THE BUILDING AREA. FOOTINGS ON SLOPES OF MORE THAN 1:10 NEED TO BE STEPPED SUCH THAT THE BOTTOM OF THE FOOTING AND TOP OF THE STEM WALL ARE LEVEL.

ANCHOR BOLTS ARE TO BE 1/2" MINIMUM DIAMETER AND EXTEND AT LEAST 7" INTO THE FIRST POUR OF CONCRETE FOUNDATIONS. ANCHOR BOLTS ARE TO BE SPACED A MAXIMUM OF 6' APART OR AS SPECIFIED ON THE PLANS. A MINIMUM OF TWO BOLTS ARE REQUIRED IN EACH PIECE OF SILL PLATE AS WELL AS ONE BOLT WITHIN 12" OF EACH END. PLATE WASHERS A MINIMUM OF 3"X3"X.229" SHALL BE USED ON EACH BOLT, THE HOLE IN THE PLATE WASHER IS PERMITTED TO BE DIAGONALLY SLOTTED WITH A WIDTH UP TO 3/16" LARGER THAN THE BOLT DIAMETER AND A SLOT LENGTH NOT TO EXCEED 1-3/4", PROVIDED A STANDARD CUT WASHER IS PLACED BETWEEN THE PLATE WASHER AND THE NUT.

THE MINIMUM THICKNESS OF A CONCRETE SLAB IS 31/2".

WOOD FRAMING MEMBERS, INCLUDING WOOD SHEATHING, THAT REST ON EXTERIOR FOUNDATION WALLS AND ARE LESS THAN 8 INCHES FROM EXPOSED EARTH SHALL BE OF NATURALLY DURABLE OR PRESERVATIVE TREATED WOOD.

ALL FILL MATERIAL SHALL BE COMPACTED TO 90 PERCENT OF MAXIMUM DENSITY AS DETERMINED BY ASTM 1557 MODIFIED PROCTOR, IN LIFTS NOT EXCEEDING 12 INCHES IN DEPTH.

ROOF AND CEILING FRAMING REQUIREMENTS SEE ALSO STRUCTURAL DRAWINGS

RAFTER, CEILING JOISTS ARE TO BE LATERALLY SUPPORTED (BLOCKED) TO

ROOF SHEATHING JOINTS ARE TO OCCUR OVER SUPPORTS. PLYWOOD IS TO BE BONDED BY EXTERIOR TYPE GLUE. TYPICAL PLYWOOD NAILING, UNLESS SPECIFIED OTHERWISE ON THE PLANS, IS 6" ON THE EDGES AND 12" IN THE

CLASS "A" ROOFING ASSEMBLY IS REQUIRED.

AN OPENING NOT LESS THAN 20"X30" SHALL BE PROVIDED TO ANY ATTIC AREA HAVING A CLEAR HEIGHT OF OVER 30". A 30" MINIMUM CLEAR HEADROOM IN THE ATTIC SPACE SHALL BE PROVIDED AT OR ABOVE THE ACCESS OPENING.

SIGNAGE NOTES:

ADDRESS SIGN SHALL BE ON THE JOB SITE AT THE TIME OF FIRST INSPECTION -- ADDRESS SIGNAGE SHALL BE CLEARLY VISIBLE FROM THE STREET, AND OF A COLOR THAT CLEARLY CONTRASTS WITH THE BACKGROUND, ADDRESS NUMBERS SHALL BE AT LEAST 4 INCHES TALL WITH A MINIMUM STROKE WIDTH OF 0.5 INCH. THESE NUMBER SHALL BE ARABIC NUMERALS OR ALPHABETICAL LETTERS.

WATER-PROOFING:

WATERPROOFING, SEALANT, CAULKING, AND FLASHING, ETC., LOCATIONS SHOWN ON DRAWINGS ARE NOT INTENDED TO BE INCLUSIVE. FOLLOW MANUFACTURER'S INSTALLATION RECOMMENDATIONS AND STANDARD INDUSTRY AND BUILDING PRACTICES.

PORTA-POTTI NOTES:

CHANGES IN LEVEL ALONG

ACCESSIBLE ROUTE

12" DIA., 1/4" THICK, UNISEX TOILET

ROOM A.D.A. DOOR-MOUNTED

STROOM SIGNAGE

PORTA-POTTI SIGN SHALL BE ON THE JOB SITE AT THE TIME OF FIRST

10 max

SIDE REACH AT COMMUNITY

KIOSK DISPLAY

FIRE SPRINKLER SYSTEM

PROVIDE COMPLETE SPRINKLER SYSTEM IN ACCORDANCE WITH CBC AND CITY OF OAKDALE REQUIREMENTS

AUTOMATIC FIRE SPRINKLER SYSTEM SHALL BE DESIGNED AND INSTALLED BY AN EXPERIENCED FIRE PROTECTION CONTRACTOR IN STRICT ACCORDANCE WITH THE REQUIREMENTS OF THE BUILDING OWNER, OWNER'S FIRE INSURANCE UNDERWRITER, AND ALL GOVERNMENTAL AGENCIES AND AUTHORITIES HAVING JURISDICTION OVER THE PREMISES.

COMPREHENSIVE SHOP DRAWINGS AND CALCULATIONS SHALL BE SUBMITTED BY THE CONTRACTOR FOR THE APPROVAL BY THE BUILDING OWNER, OWNER'S FIRE INSURANCE UNDERWRITER, AND LOCAL AUTHORITIES

VERY IMPORTANT:

SPRINKLER SHOP DRAWINGS SHALL BE SUBMITTED TO LOCAL AUTHORITIES FOR APPROVAL BEFORE ANY INSTALLATION CAN BEGIN. APPROVED DRAWINGS MUST BE AT THE JOB SITE DURING CONSTRUCTION.

FIRE PROTECTION PLANS (SPRINKLER DRAWINGS) MUST BE ENGINEERED AND WET SEALED BY A LICENSED REGISTERED FIRE PROTECTION ENGINEER IN THE STATE OF CALIFORNIA. SUBMIT TWO (2) SETS OF WET SEALED FIRE PROTECTION

PLANS AND TWO (2) COPIES OF HYDRAULIC CALCULATIONS TO BUILDING OWNER. SUBMIT 4 COPIES TO FIRE DEPARTMENT PRIOR TO INSTALLATION. COORDINATE TESTING WITH LOCAL AUTHORITIES AND FIRE DEPARTMENT.

VERIFY ALL SUBMITTAL REQUIREMENTS WITH LOCAL AUTHORITIES SHOP DRAWINGS TO INCLUDE, BUT NOT LIMITED TO:

1. LOCATION OF SPRINKLER HEAD GRID WITH MAIN AND BRANCH PIPE SIZES.

2. TEMPERATURE RATING OF ALL HEADS. 3. FIRE EXTINGUISHER LOCATIONS.

COORDINATE DRAIN DOWN AND HYDROTEST WITH LOCAL AUTHORITIES THE CONTRACTOR SHALL PROVIDE ALL LABOR, MATERIALS AND WORKMANSHIP TO PROVIDE NEW FIRE SPRINKLER SYSTEM AS REQUIRED TO SUIT BUILDING

CONDITIONS AND SHALL PREPARE HYDRAULIC CALCULATIONS AND SHOP

REGULATIONS OF ALL CODES AND ORDINANCES ENFORCED FOR WORK

DRAWINGS IN FULL ACCORDANCE WITH THE LATEST RULES AND

PERFORMED. PAINTING, CAULKING OR MODIFYING OF SPRINKLERS SHALL BE PROHIBITED. SPRINKLERS THAT HAVE BEEN PAINTED, CAULKED, MODIFIED OR DAMAGED

SHALL BE REPLACED WITH NEW SPRINKLERS. WITH THE EXCEPTION OF SHUTOFF VALVES FOR THE ENTIRE WATER DISTRIBUTION SYSTEM, VALVES SHALL NOT BE INSTALLED IN ANY LOCATION WHERE THE VALVE WOULD ISOLATE PIPING SERVING ONE OR MORE

A MEANS TO DRAIN THE SPRINKLER SYSTEM SHALL BE PROVIDED ON THE SYSTEM SIDE OF THE WATER DISTRIBUTION SHUTOFF VALVE.

INSTRUCTIONS AND SIGNS. AN OWNER'S MANUAL FOR THE FIRE SPRINKLER SYSTEM SHALL BE PROVIDED TO THE OWNER. A SIGN OR VALVE TAG SHALL BE INSTALLED AT THE MAIN SHUTOFF VALVE TO THE WATER DISTRIBUTION SYSTEM STATING THE FOLLOWING: "WARNING, THE WATER SYSTEM FOR THIS BUILDING SUPPLIES FIRE SPRINKLERS THAT REQUIRE CERTAIN FLOWS AND PRESSURES TO FIGHT A FIRE. DEVICES THAT RESTRICT THE FLOW OR DECREASE THE PRESSURE OR AUTOMATICALLY SHUT OFF THE WATER TO THE FIRE SPRINKLER SYSTEM, SUCH AS WATER SOFTENERS, FILTRATION SYSTEMS AND AUTOMATIC SHUTOFF VALVES, SHALL NOT BE ADDED TO THIS SYSTEM WITHOUT A REVIEW OF THE FIRE SPRINKLER SYSTEM BY A FIRE PROTECTION SPECIALIST. DO NOT REMOVE THIS SIGN."

TERMITE CONTROL

OWNER TO HIRE OUTSIDE PEST CONTROL SERVICE, SUCH AS "TERMINIX" CONTRACTOR TO COORDINATE WITH OWNER. SO THAT THE INITIAL CHEMICAL TREATMENT CAN BE APPLIED AT THE APPROPRIATE PHASE OF CONSTRUCTION.

SITE PLAN NOTES:

PUSH SIDE

WHEN INSTALLED, DOORS SHALL BE CAPABLE OF

OPENING SO THAT CLEAR WIDTH IN NOT LESS

THAN 32". WHEN INSTALLED, DOORS SHALL BE CAPABLE OF OPENING AT LEAST 90 DEGREES

AND SHALL BE MOUNTED THAT THE CLEAR WIDTH

IS NOT LESS THAN 32", MEASURED BETWEEN THE

FACE OF THE DOOR AND THE OPPOSITE STOP.

SEE ALSO SITE PLANS

PULL SIDE

TOUCH SCREEN

 CONTROLS LOCATED WITHIN THIS AREA

MANEUVERING CLEARANCE

AT SWINGING DOOR

IF GRADING OR OTHER CONSTRUCTION OPERATIONS UNCOVER ARCHAEOLOGICAL, HISTORIC OR OTHER RESOURCES, CONSTRUCTION SHALL CEASE AND THE PLANNING DEPARTMENT SHALL BE NOTIFIED OF THE EXTENT AND LOCATION OF DISCOVERED MATERIALS SO THAT THEY MAY BE RECORDED BY A QUALIFIED ARCHAEOLOGIST. DISPOSITION OF ARTIFACTS SHALL COMPLY WITH STATE AND FEDERAL LAWS.

THOMAS ROMAN ARCHITECT HAS NOT STUDIED OR EXPRESSED ANY OPINION CONCERNING STABILITY OF SOILS, OR THE RISK OF SLIDES, FLOODING OR EARTH MOVEMENT, UNDER OR EARTH MOVEMENT, UNDER OR IN THE VICINITY OF THE BUILDING SITE. SUCH STUDIES AND OPINIONS CAN BE GIVEN ONLY BY A QUALIFIED, LICENSED SOILS ENGINEER.

12" MIN. OF DOOR

BOTH CLOSER AND

IS EQUIPPED WITH

CAL-GREEN NOTES

COMPOSITE WOOD PRODUCTS - PER CAL-GREEN: MOISTURE CONTENT OF BLDG MAT'LS - PER CAL-GREEN:

WALL AND FLOOR FRAMING SHALL NOT BE ENCLOSED WHEN THE FRAMING MEMBERS EXCEED 19 PERCENT MOISTURE CONTENT.

INSULATION PRODUCTS WHICH ARE VISIBLY WET OR HAVE A HIGH MOISTURE CONTENT SHALL BE REPLACED OR ALLOWED TO DRY PRIOR TO ENCLOSURE IN WALL OR FLOOR CAVITIES. WET-APPLIED INSULATION PRODUCTS SHALL FOLLOW THE MANUFACTURERS' DRYING RECOMMENDATIONS PRIOR TO ENCLOSURE.

BUILDING MATERIALS WITH VISIBLE SIGNS OF WATER DAMAGE SHALL NOT BE

INDOOR WATER USE - PER CAL-GREEN:

PLUMBING FIXTURES AND FIXTURE FITTINGS SHALL REDUCE THE OVERALL USE OF POTABLE WATER WITHIN THE BUILDING BY AT LEAST 20 PERCENT BASED ON THE MAXIMUM ALLOWABLE WATER USE PER PLUMBING FIXTURE AND FITTING AS REQUIRED BY THE CALIFORNIA BUILDING STANDARDS CODE. THE 20 PERCENT REDUCTION IN POTABLE WATER USE SHALL BE DEMONSTRATED BY PROVIDING PLUMBING FIXTURE AND FITTING THAT MEET THE REDUCED FLOW RATES SPECIFIED BELOW:

WATER CLOSET = 1.28 GALLONS PER FLUSH MAX. SHOWERHEAD = 2 GPM MAX. AT 80 PSI LAVATORY FAUCETS = 1.5 GPM MAX. AT 60 PSI KITCHEN FAUCETS = 1.8 GPM MAX. AT 60 PSI

AS AN ALTERNATIVE TO THE FIXTURE FLOW RATES ITEMIZED ABOVE, THE CONTRACTOR MAY PROVIDE TO THE BUILDING DEPARTMENT A CALCULATION DEMONSTRATING A 20 PERCENT REDUCTION IN THE BUILDING "WATER USE" BASELINE AS ESTABLISHED IN TABLE 4:303.1.

OUTDOOR WATER USE - PER CAL-GREEN

AUTOMATIC IRRIGATION SYSTEMS SHALL BE WEATHER-BASED.

HVAC INSTALLER TRAINING - PER CAL-GREEN:

HVAC SYSTEM INSTALLERS SHALL BE TRAINED AND CERTIFIED IN THE PROPER INSTALLATION OF HVAC SYSTEMS INCLUDING DUCTS AND EQUIPMENT BY A NATIONALLY OR REGIONALLY RECOGNIZED TRAINING OR CERTIFICATION PROGRAM, UNCERTIFIED PERSONS MAY PERFORM HVAC INSTALLATIONS WHEN UNDER THE DIRECT SUPERVISION AND RESPONSIBILITY OF A PERSON TRAINED AND CERTIFIED TO INSTALL HVAC SYSTEMS OR CONTRACTOR LICENSED TO

INSTALL HVAC SYSTEMS. EXAMPLES OF ACCEPTABLE HVAC TRAINING AND CERTIFICATION PROGRAMS INCLUDE BUT ARE NOT LIMITED TO THE FOLLOWING: 1. STATE CERTIFIED APPRENTICESHIP PROGRAMS

2. PUBLIC UTILITY TRAINING PROGRAMS 3. TRAINING PROGRAMS SPONSORED BY TRADE, LABOR OR STATEWIDE ENERGY CONSULTING OR VERIFICATION ORGANIZATIONS. 4. PROGRAMS SPONSORED BY MANUFACTURING ORGANIZATIONS 5. OTHER PROGRAMS ACCEPTABLE TO THE ENFORCING AGENCY

PROTECTION OF OPENINGS - PER CAL-GREEN: DUCT OPENINGS AND OTHER RELATED AIR DISTRIBUTION COMPONENT OPENINGS SHALL BE COVERED DURING CONSTRUCTION.

OPERATION AND

MAINTENANCE MANUAL - PER CAL GREEN:

AT THE TIME OF FINAL INSPECTION, A MANUAL, COMPACT DISC, WEB-BASED REFERENCE OR OTHER MEDIA ACCEPTABLE TO THE ENFORCING AGENCY WHICH INCLUDES ALL OF THE FOLLOWING SHALL BE PLACED IN THE BUILDING: 1. DIRECTIONS TO THE OWNER OR OCCUPANT THAT THE MANUAL SHALL REMAIN WITH THE BUILDING THROUGHOUT THE LIFE CYCLE OF THE

2. OPERATION AND MAINTENANCE INSTRUCTIONS FOR THE FOLLOWING: A. EQUIPMENT AND APPLIANCES, INCLUDING WATER-SAVING DEVICES AND SYSTEMS, HVAC SYSTEMS, WATER-HEATING SYSTEMS AND OTHER MAJOR APPLIANCES AND EQUIPMENT

B. ROOF AND YARD DRAINAGE, INCLUDING GUTTERS AND DOWNSPOUTS.

C. SPACE CONDITIONING SYSTEMS, INCLUDING CONDENSERS AND AIR D. LANDSCAPE IRRIGATION SYSTEMS.

E. WATER REUSE SYSTEMS. 3. INFORMATION FROM LOCAL UTILITY, WATER AND WASTE RECOVERY PROVIDERS ON METHODS TO FURTHER REDUCE RESOURCE CONSUMPTION. INCLUDING RECYCLE PROGRAMS AND LOCATIONS.

4. PUBLIC TRANSPORTATION AND/OR CARPOOL OPTIONS AVAILABLE IN THE 5. EDUCATIONAL MATERIAL ON THE POSITIVE IMPACTS OF AN INTERIOR RELATIVE HUMIDITY BETWEEN 30-60 PERCENT AND WHAT METHODS AN OCCUPANT MAY USE TO MAINTAIN THE RELATIVE HUMIDITY LEVEL IN THAT

6. INFORMATION ABOUT WATER-CONSERVING LANDSCAPE AND IRRIGATION DESIGN AND CONTROLLERS WHICH CONSERVE WATER. 7. INSTRUCTIONS FOR MAINTAINING GUTTERS AND DOWNSPOUTS AND THE IMPORTANCE OF DIVERTING WATER AT LEAST 5 FEET AWAY FROM THE

FOUNDATION. 8. INFORMATION ON REQUIRED ROUTINE MAINTENANCE MEASURES, INCLUDING, BUT NOT LIMITED TO, CAULKING, PAINTING, GRADING AROUND THE BUILDING, ETC 9. INFORMATION ABOUT STATE SOLAR ENERGY AND INCENTIVE PROGRAMS

PROTECTION SYSTEMS:

ENFORCING AGENCY OR THIS CODE.

AVAILABLE.

PROVIDE BLOCKING /

AS REQUIRED

3'-6" MIN.

6" MAX.

FEMININE NAPKIN

HOLDER W/O STOPS

ACCESSIBLE TOILET STALL

TOILET PAPER

DISPOSAL

BACKING AT GRAB BARS

1-1'2" DIAMETER

GRAB BAR

- MINIMUM 36"

STAINLESS STEEL

PROTECT ANNULAR SPACES AROUND PIPES, ELECTRICAL CABLES, CONDUITS AT EXTERIOR WALLS AGAINST THE PASSAGE OF RODENTS.

10. A COPY OF ALL SPECIAL INSPECTION VERIFICATIONS REQUIRED BY THE

COMPLY WITH CAL-GREEN SECTION 4.504 POLLUTANT CONTROL HARDWOOD PLYWOOD, PARTICLEBOARD AND MEDIUM DENSITY FIBERBOARD COMPOSITE WOOD PRODUCTS USED ON THE INTERIOR OR EXTERIOR OF THE BUILDING SHALL MEET THE REQUIREMENTS FOR FORMALDEHYDE AS SPECIFIED IN ARB'S AIR TOXICS CONTROL MEASURE FOR COMPOSITE WOOD (17 CCR 93120 ET SEQ.), BY OR BEFORE THE DATES SPECIFIED IN THOSE SECTIONS, AS SHOWN IN CAL-GREEN TABLE 4.504.5

PAINTS AND COATINGS:

COMPLY WITH CAL-GREEN SECTION 4.504 POLLUTANT CONTROL ARCHITECTURAL PAINTS AND COATINGS SHALL COMPLY WITH VOC LIMITS IN TABLE 1 OF THE ARB ARCHITECTURAL SUGGESTED CONTROL MEASURE, AS SHOWN IN CAL-GREEN TABLE 4.504.3. UNLESS MORE STRINGENT LOCAL LIMITS

THE VOC CONTENT LIMIT FOR COATINGS THAT DO NOT MEET THE DEFINITIONS FOR THE SPECIALTY COATINGS CATEGORIES LISTED IN CAL-GREEN TABLE 4.504.3 SHALL BE DETERMINED BY CLASSIFYING THE COATING AS A FLAT, NONFLAT OR NONFLAT HIGH GLOSS COATING, BASED ON ITS GLOSS, AS DEFINED IN SUBSECTIONS 4.21, 4.36, AND 4.37 OF THE 2007 CALIFORNIA AIR RESOURCES BOARD, SUGGESTED CONTROL MEASURE, AND THE CORRESPONDING FLAT, NONFLAT OR NONFLAT-HIGH GLOSS VOC LIMIT IN CAL-GREEN TABLE 4.504.3 SHALL APPLY.

CARPETING:

COMPLY WITH CAL-GREEN SECTION 4.504 POLLUTANT CONTROL ALL CARPET INSTALLED IN THE BUILDING INTERIOR SHALL MEET THE TESTING AND PRODUCT REQUIREMENTS OF ONE OF THE FOLLOWING: 1. CARPET AND RUG INSTITUTE'S GREEN LABEL PLUS PROGRAM. 2. CALIFORNIA DEPARTMENT OF PUBLIC HEALTH STANDARD PRACTICE FOR THE TESTING OF VOCS (SPECIFICATION 01350) 3. NSF/ANSI 140 AT THE GOLD LEVEL. 4. SCIENTIFIC CERTIFICATIONS SYSTEMS INDOOR ADVANTAGE(TM) GOLD.

ALL CARPET CUSHION INSTALLED IN THE BUILDING INTERIOR SHALL MEET THE REQUIREMENTS OF THE CARPET AND RUG INSTITUTE GREEN LABEL PROGRAM. ALL CARPET ADHESIVE SHALL MEET THE REQUIREMENTS OF CAL-GREEN

RESILIENT FLOORING

TABLE 4.504.1

COMPLY WITH CAL-GREEN SECTION 4.504 POLLUTANT CONTROL WHERE RESILIENT FLOORING IS INSTALLED, AT LEAST 50 PERCENT OF FLOOR AREA RECEIVING RESILIENT FLOORING SHALL COMPLY WITH THE VOC EMISSION LIMITS DEFINED IN THE COLLABORATIVE FOR HIGH PERFORMANCE SCHOOLS (CHPS) LOW-EMITTING MATERIALS LIST OR CERTIFIED UNDER THE RESILIENT FLOOR COVERING INSTITUTE (RFCI) FLOORSCORE PROGRAM.

POLLUTION CONTROL:

COMPLY WITH CAL-GREEN SECTION 4.504 POLLUTANT CONTROL ADHESIVES, SEALANTS AND CAULKS SHALL BE COMPLIANT WITH VOC AND OTHER TOXIC COMPOUND LIMITS IN ACCORDANCE WITH CALGREEN SECTION 4.504.2.1. AEROSOL PAINTS AND COATINGS SHALL BE COMPLIANT WITH PRODUCT WEIGHTED MIR LIMITS FOR ROC AND OTHER TOXIC COMPOUNDS IN ACCORDANCE WITH CALGREEN

SECTION 4.504.2.3. CONTRACTOR SHALL PROVIDE VERIFICATION OF COMPLIANCE.

INTERIOR MOISTURE CONTROL

INSTALL CAPILLARY BREAK AND VAPOR RETARDER AT SLAB ON GRADE FOUNDATIONS IN ACCORDANCE WITH CALGREEN SECTION 4.505.2.

CONSTRUCTION WASTE

MANAGEMENT PLAN - PER CAL GREEN:

COMPLY WITH CAL-GREEN WASTE MANAGEMENT REQUIREMENTS CONTRACTOR SHALL SUBMIT CONSTRUCTION WASTE MANAGEMENT PLAN IN ACCORDANCE WITH CALGREEN SECTION 4.408.2, AND IN ACCORDANCE WITH LOCAL ORDINANCES.

CONTRACTOR SHALL DIVERT A MINIMUM OF 50% OF THE CONSTRUCTION WASTE TO RECYCLE OR SALVAGE PER CALGREEN SECTION 4.408.1. CONTRACTOR SHALL PROVIDE DOCUMENTATION TO THE ENFORCING AGENCY

WHICH DEMONSTRATES COMPLIANCE WITH THE FOLLOWING 1. IDENTIFIES THE MATERIALS TO BE DIVERTED FROM DISPOSAL BY RECYCLING, REUSE ON THE PROJECT OR SALVAGE FOR FUTURE USE OR SALE. 2. SPECIFIES IF MATERIALS WILL BE SORTED ON-SITE OR MIXED FOR TRANSPORTATION TO A DIVERSION FACILITY. 3. IDENTIFIES THE DIVERSION FACILITY WHERE THE MATERIAL COLLECTED WILL 4. IDENTIFIES CONSTRUCTION METHODS EMPLOYED TO REDUCE THE AMOUNT OF WASTE GENERATED.

CALCULATED BY WEIGHT OR VOLUME, BUT NOT BY BOTH. CONTRACTOR SHALL UPDATE THE WASTE MANAGEMENT PLAN AS NECESSARY THE WASTE MANAGEMENT PLAN SHALL BE ACCESSIBLE DURING CONSTRUCTION FOR EXAMINATION BY THE ENFORCING AGENCY.

5. SPECIFIES THAT THE AMOUNT OF MATERIALS DIVERTED SHALL BE

MIXED CONSTRUCTION AND DEMOLITION DEBRIS (C&D) PROCESSORS CAN BE LOCATED AT THE CALIFORNIA DEPARTMENT OF RESOURCES RECYCLING AND RECOVERY (CALRECYCLE).

<u>DUCT SYSTEMS:</u>

COMPLY WITH CAL-GREEN SECTION 4.507

DUCT SYSTEMS AND EQUIPMENT SHALL BE SIZED AND DESIGNED IN ACCORDANCE WITH CALGREEN SECTION 4.507.2

KNOX KEY BOX:

PROVIDE KEY BOX IN ACCORDANCE WITH CITY OF OAKDALE FIRE DEPARTMENT REQUIREMENTS - STANDARD SPECIFICATIONS 10-H AND 10-H-1.

COORDINATE LOCATIONS, MATERIALS AND INSTALLATION WITH OAKDALE FIRE

DEPARTMENT ONLY THE PRODUCT LINE OFFERED BY THE KNOX COMPANY, OF IRVINE, SATISFIES THE SECURITY NEEDS OF THE OAKDALE FIRE DEPARTMENT - MODEL TO BE

DETERMINED. ORDER FORM WILL BE PROVIDED BY THE OAKDALE FIRE DEPARTMENT. THE KEY BOX SHALL BE MOUNTED NOT LESS THAN 5 FT. AND NOT GREATER THAN 6 FT. ABOVE THE FINISH FLOOR AND NOT MORE THAN 3 FT. FROM THE

RIGHT SIDE OF THE MAIN ENTRANCE TO THE BUILDING. A KNOX DECAL SHALL BE PLACED ON THE ENTRANCE DOOR.

THE BOX SHALL BE MOUNTED USING HEAVY "LAG BOLTS" OR OTHER STURDY DEVICES TO SECURE THE BOX TO THE WALL. IF A BOX WITH TAMPER SWITCHES IS REQUIRED, THE SWITCHES SHOULD BE

CONNECTED WITH AND TESTED BY THE SECURITY ALARM COMPANY BEFORE

CLOSING THE FACE AS ALL WIRING WOULD THEN BE SEALED. ASSEMBLE ALL OF THE FOLLOWING KEYS FOR PLACEMENT INTO THE BOX:

- ONE FOR MAIN ENTRY - ONE FOR FIRE ALARM / SPRINKLER SYSTEM. - ONE GRAND MASTER KEY

AFTER INSTALLATION OF THE KNOX LOCK SAFE. CONTACT OAKDALE FIRE

DEPARTMENT TO TEST AND SECURE THE ACCESS KEYS INTO THE SAFE.

STOCKTON:


MAX. OCCUPANT LOAD SIGNS:

PROVIDE MAXIMUM OCCUPANT LOAD SIGNAGE IN ACCORDANCE WITH THE REQUIREMENTS OF THE CITY OF OAKDALE DESIGN SPECIFICATIONS 10-9 AND 10-J-1, THE CALIFORNIA FIRE CODE, THE OAKDALE FIRE DEPARTMENT, AND TILE 19 CALIFORNIA ADMINISTRATIVE CODE.

THE MAXIMUM OCCUPANT CAPACITY SHALL BE DETERMINED BY THE CHIEF BUILDING OFFICIAL.

ANY ASSEMBLY ROOM OR AREA NOT HAVING FIXED SEATS WITH AN OCCUPANT LOAD OF 50 OR MORE PERSONS SHALL HAVE POSTED AND MAINTAINED A ROOM CAPACITY SIGN.

THE SIGN SHALL BE POSTED NEAR THE MAIN ENTRANCE AND CLEARLY VISIBLE NO PERSON SHALL DEFACE OR REMOVE SUCH SIGNS, EXCEPT AS DIRECTED BY THE ENFORCING AGENCY.

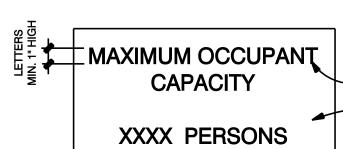

- LETTERS TO BE BLACK BACKGROUND TO BE WHITE

MAXIMUM OCCUPANT LOAD SIGNAGE SAMPLE ELEVATION THE SIGN SHALL HAVE LETTERS AT LEAST ONE (1) INCH HIGH, BLACK ON WHITE BACKGROUND MAXIMUM OCCUPANT CAPACITY SHALL BE DETERMINED BY THE OAKDALE FIRE DEPARTMENT

ACCESSIBILITY GUIDELINES

CARPET OR CARPET TILE SHALL BE SECURELY ATTACHED AND SHALL HAVE A FIRM CUSHION, PAD, OR BACKING OR NO CUSHION OR PAD. CARPET OR CARPET TILE SHALL HAVE A LEVEL LOOP, TEXTURED LOOP, LEVEL CUT PILE, OR LEVEL CUT/UNCUT PILE TEXTURE. PILE HEIGHT SHALL BE 1/2 INCH (13 MM) MAXIMUM. EXPOSED EDGES OF CARPET SHALL BE FASTENED TO FLOOR SURFACES AND SHALL HAVE TRIM ON THE ENTIRE LENGTH OF THE EXPOSED EDGE.

ACCESSIBILITY GUIDELINES - FLOORS AND LEVELS

GROUND AND FLOOR SURFACES ALONG ACCESSIBLE ROUTES AND IN ACCESSIBLE ROOMS AND SPACES. INCLUDING FLOORS, WALKS, RAMPS, AND STAIRS SHALL BE STABLE, FIRM AND SLIP RESISTANT. CHANGES IN LEVEL UP TO 1/4 INCH MAY BE VERTICAL AND WITHOUT EDGE TREATMENT

CHANGES IN LEVEL BETWEEN 1/4 INCH AND 1/2 INCH SHALL BE ACCOMPLISHED BY MEANS OF A RAMP NO STEEPER THAN 1 VERTICAL TO 2 HORIZONTAL.

ACCESSIBILITY GUIDELINES - ELECTRICAL

THE CENTER OF JUNCTION BOX FOR ELECTRICAL AND COMMUNICATION SYSTEM RECEPTACLE OUTLETS SHALL BE INSTALLED AT AN ACCESSIBLE LOCATION MEETING THE CLEARANCES AND REACH RANGE REQUIREMENTS OF SECTION 1118B AND NOT LESS THAN 15" ABOVE THE FLOOR OR WORKING PLATFORMS.

THE CENTER OF THE GRIP OF THE OPERATING HANDLE OF CONTROLS OR SWITCHES INTENDED TO BE USED BY THE OCCUPANT OF THE ROOM OR AREA TO CONTROL LIGHTING AND RECEPTACLE OUTLETS, APPLIANCES, OR COOLING, HEATING, AND VENTILATING EQUIPMENT SHALI MEET THE REQUIREMENTS OF PART 2, CALIFORNIA BUILDING CODE (CBC), SECTION 1118B, SPACE ALLOWANCE AND REACH RANGES, FOR PERSONS WITH DISABILITIES AND SHALL NOT BE MORE THAN 48" ABOVE THE FLOOR OR

THE CENTER OF FIRE ALARM INITIATING DEVICES (BOXES) SHALL BE LOCATED 48" ABOVE THE LEVEL OF THE FLOOR, WORKING PLATFORM, GROUND SURFACE, OR SIDEWALK

WORKING PLATFORM


tom@tr-architecture.com 530.205.8750 DESIGN ' BUILD

209.933.9000

209.933.1900 FAX

PALM DESERT:

760.636.5992

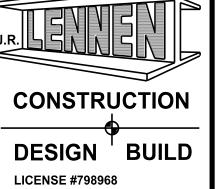

THOMAS ROMAN

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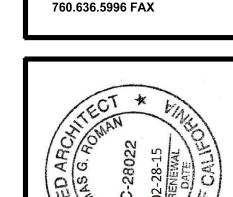
Architecture


1809 S St., PMB 362

Sacramento, CA 95811

1 Bank St., PMB 191

Grass Valley, CA 95945



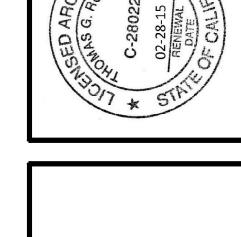


FINAL DRAWINGS PERMIT SET

ALL FIELD CHANGES TO APPROVED SET OF PLANS SHALL BE FIRST APPROVED BY THE BUILDING DEPARTMENT. FAILURE TO PROVIDE CHANGES TO THE **BUILDING DEPARTMENT WILL BE** CAUSE FOR THE DEPARTMENT TO ISSUE A STOP WORK NOTICE.


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ACCESSIBILITY




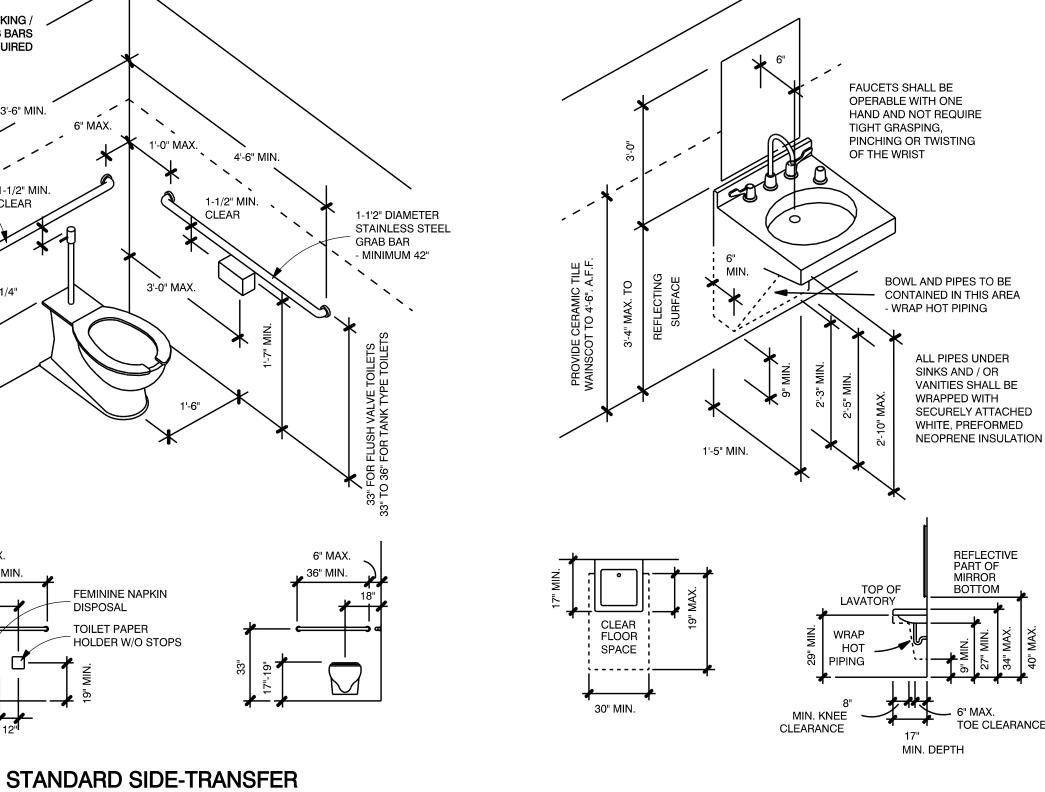

DOOR CLEARANCE **ACCESSIBILITY NOTES AND DETAILS**



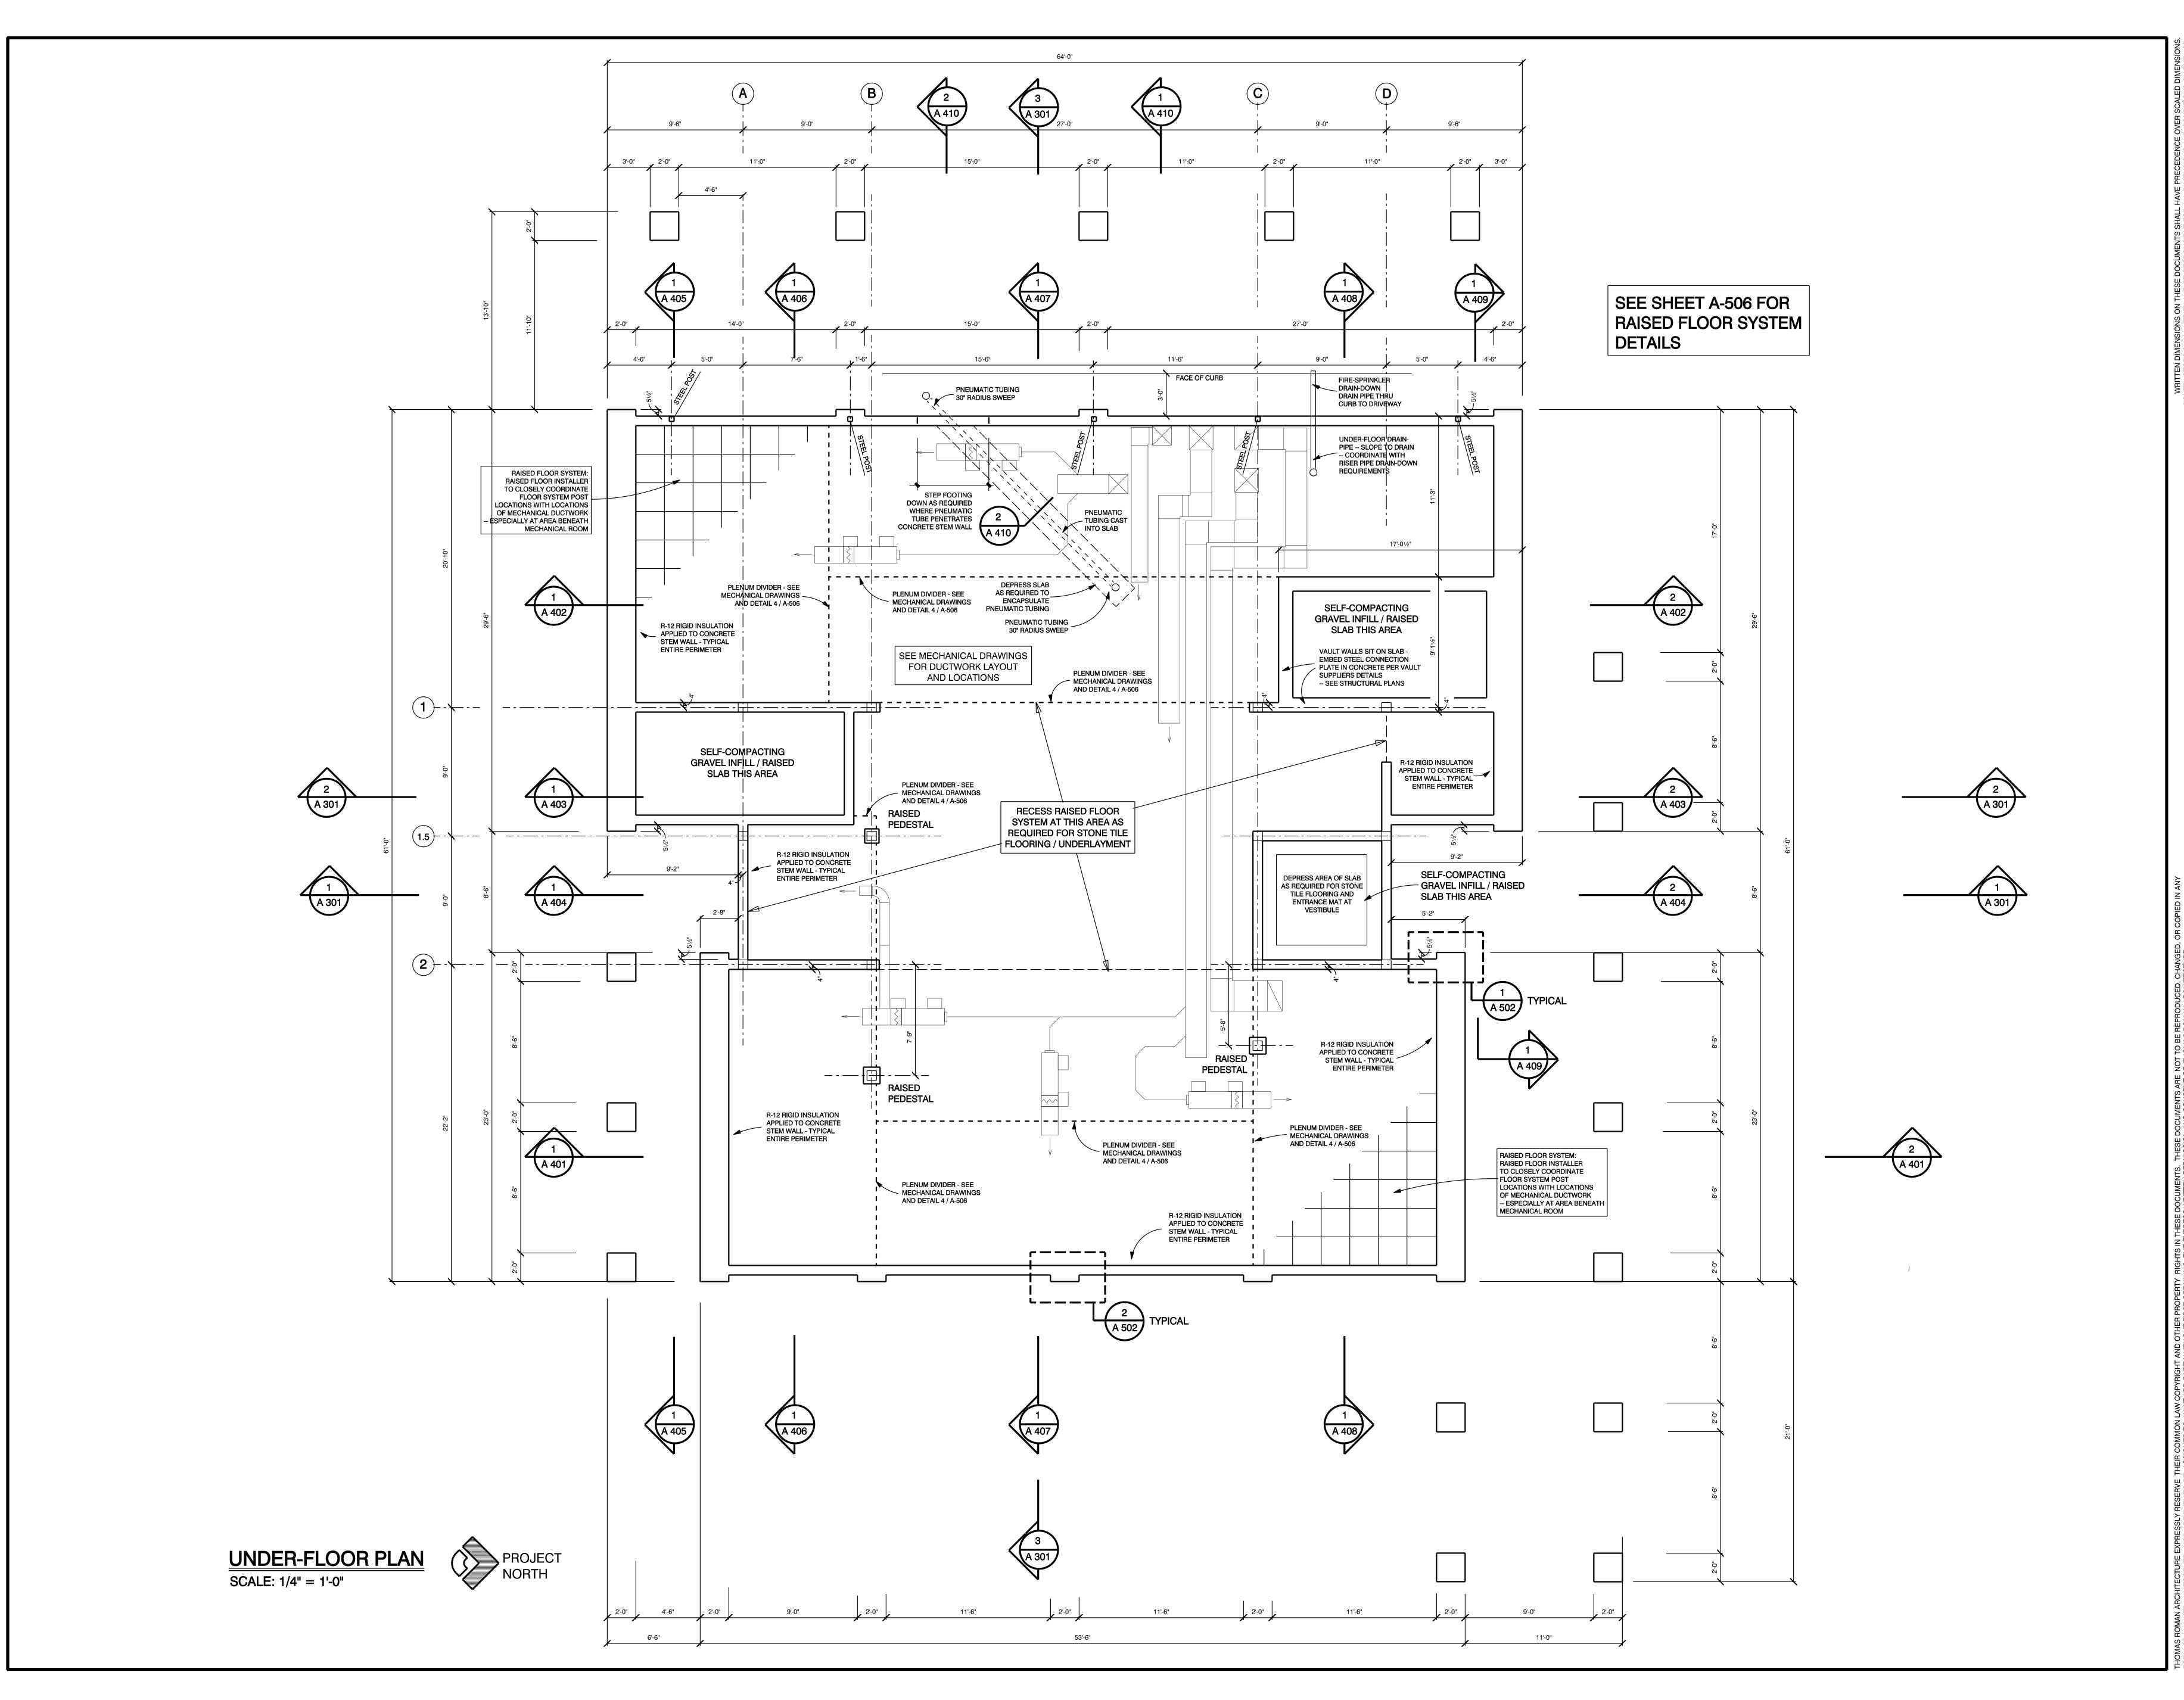

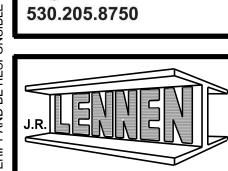

Grass Valley, CA 95945 tom@tr-architecture.com

CONSTRUCTION


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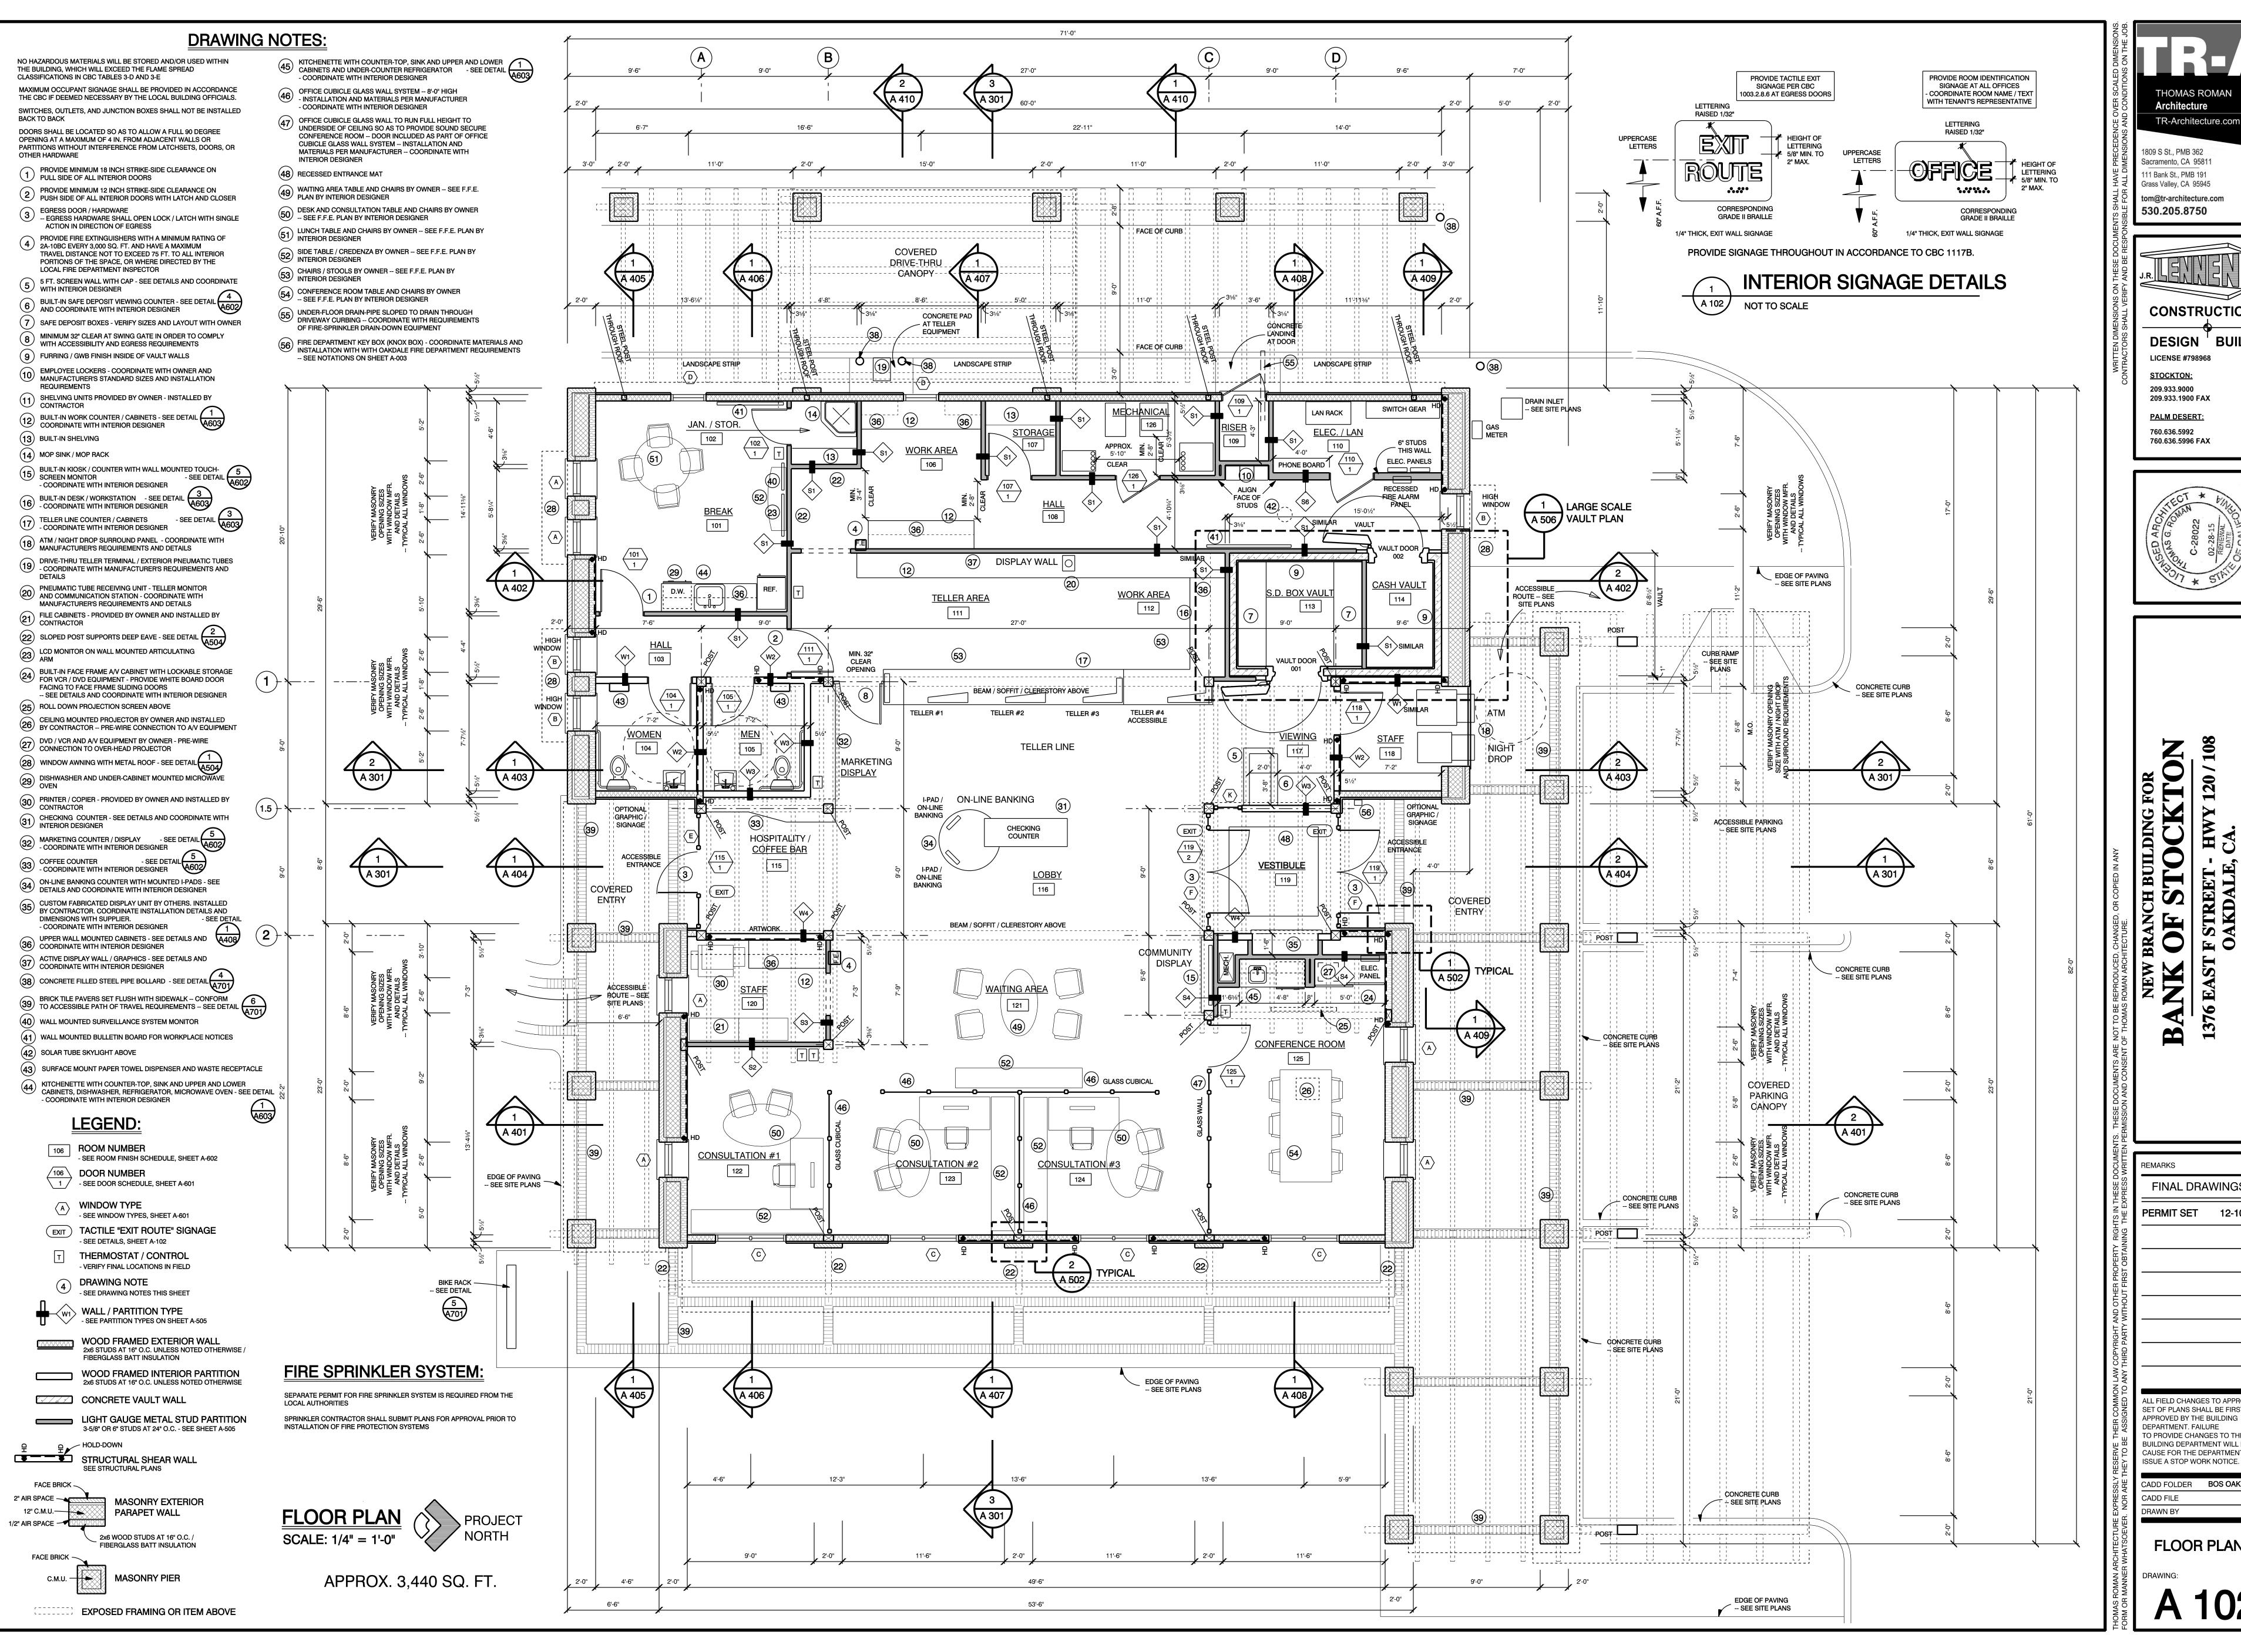
1376 EAST F STREET - HWY 120 / 10
OAKDALE, CA.


FINAL DRAWINGS
PERMIT SET 12-10-13


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CADD FOLDER BOS OAKDALE
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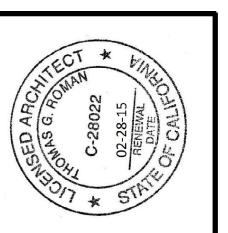
UNDER-FLOOR PLAN





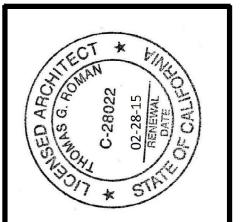
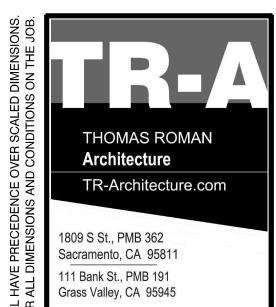
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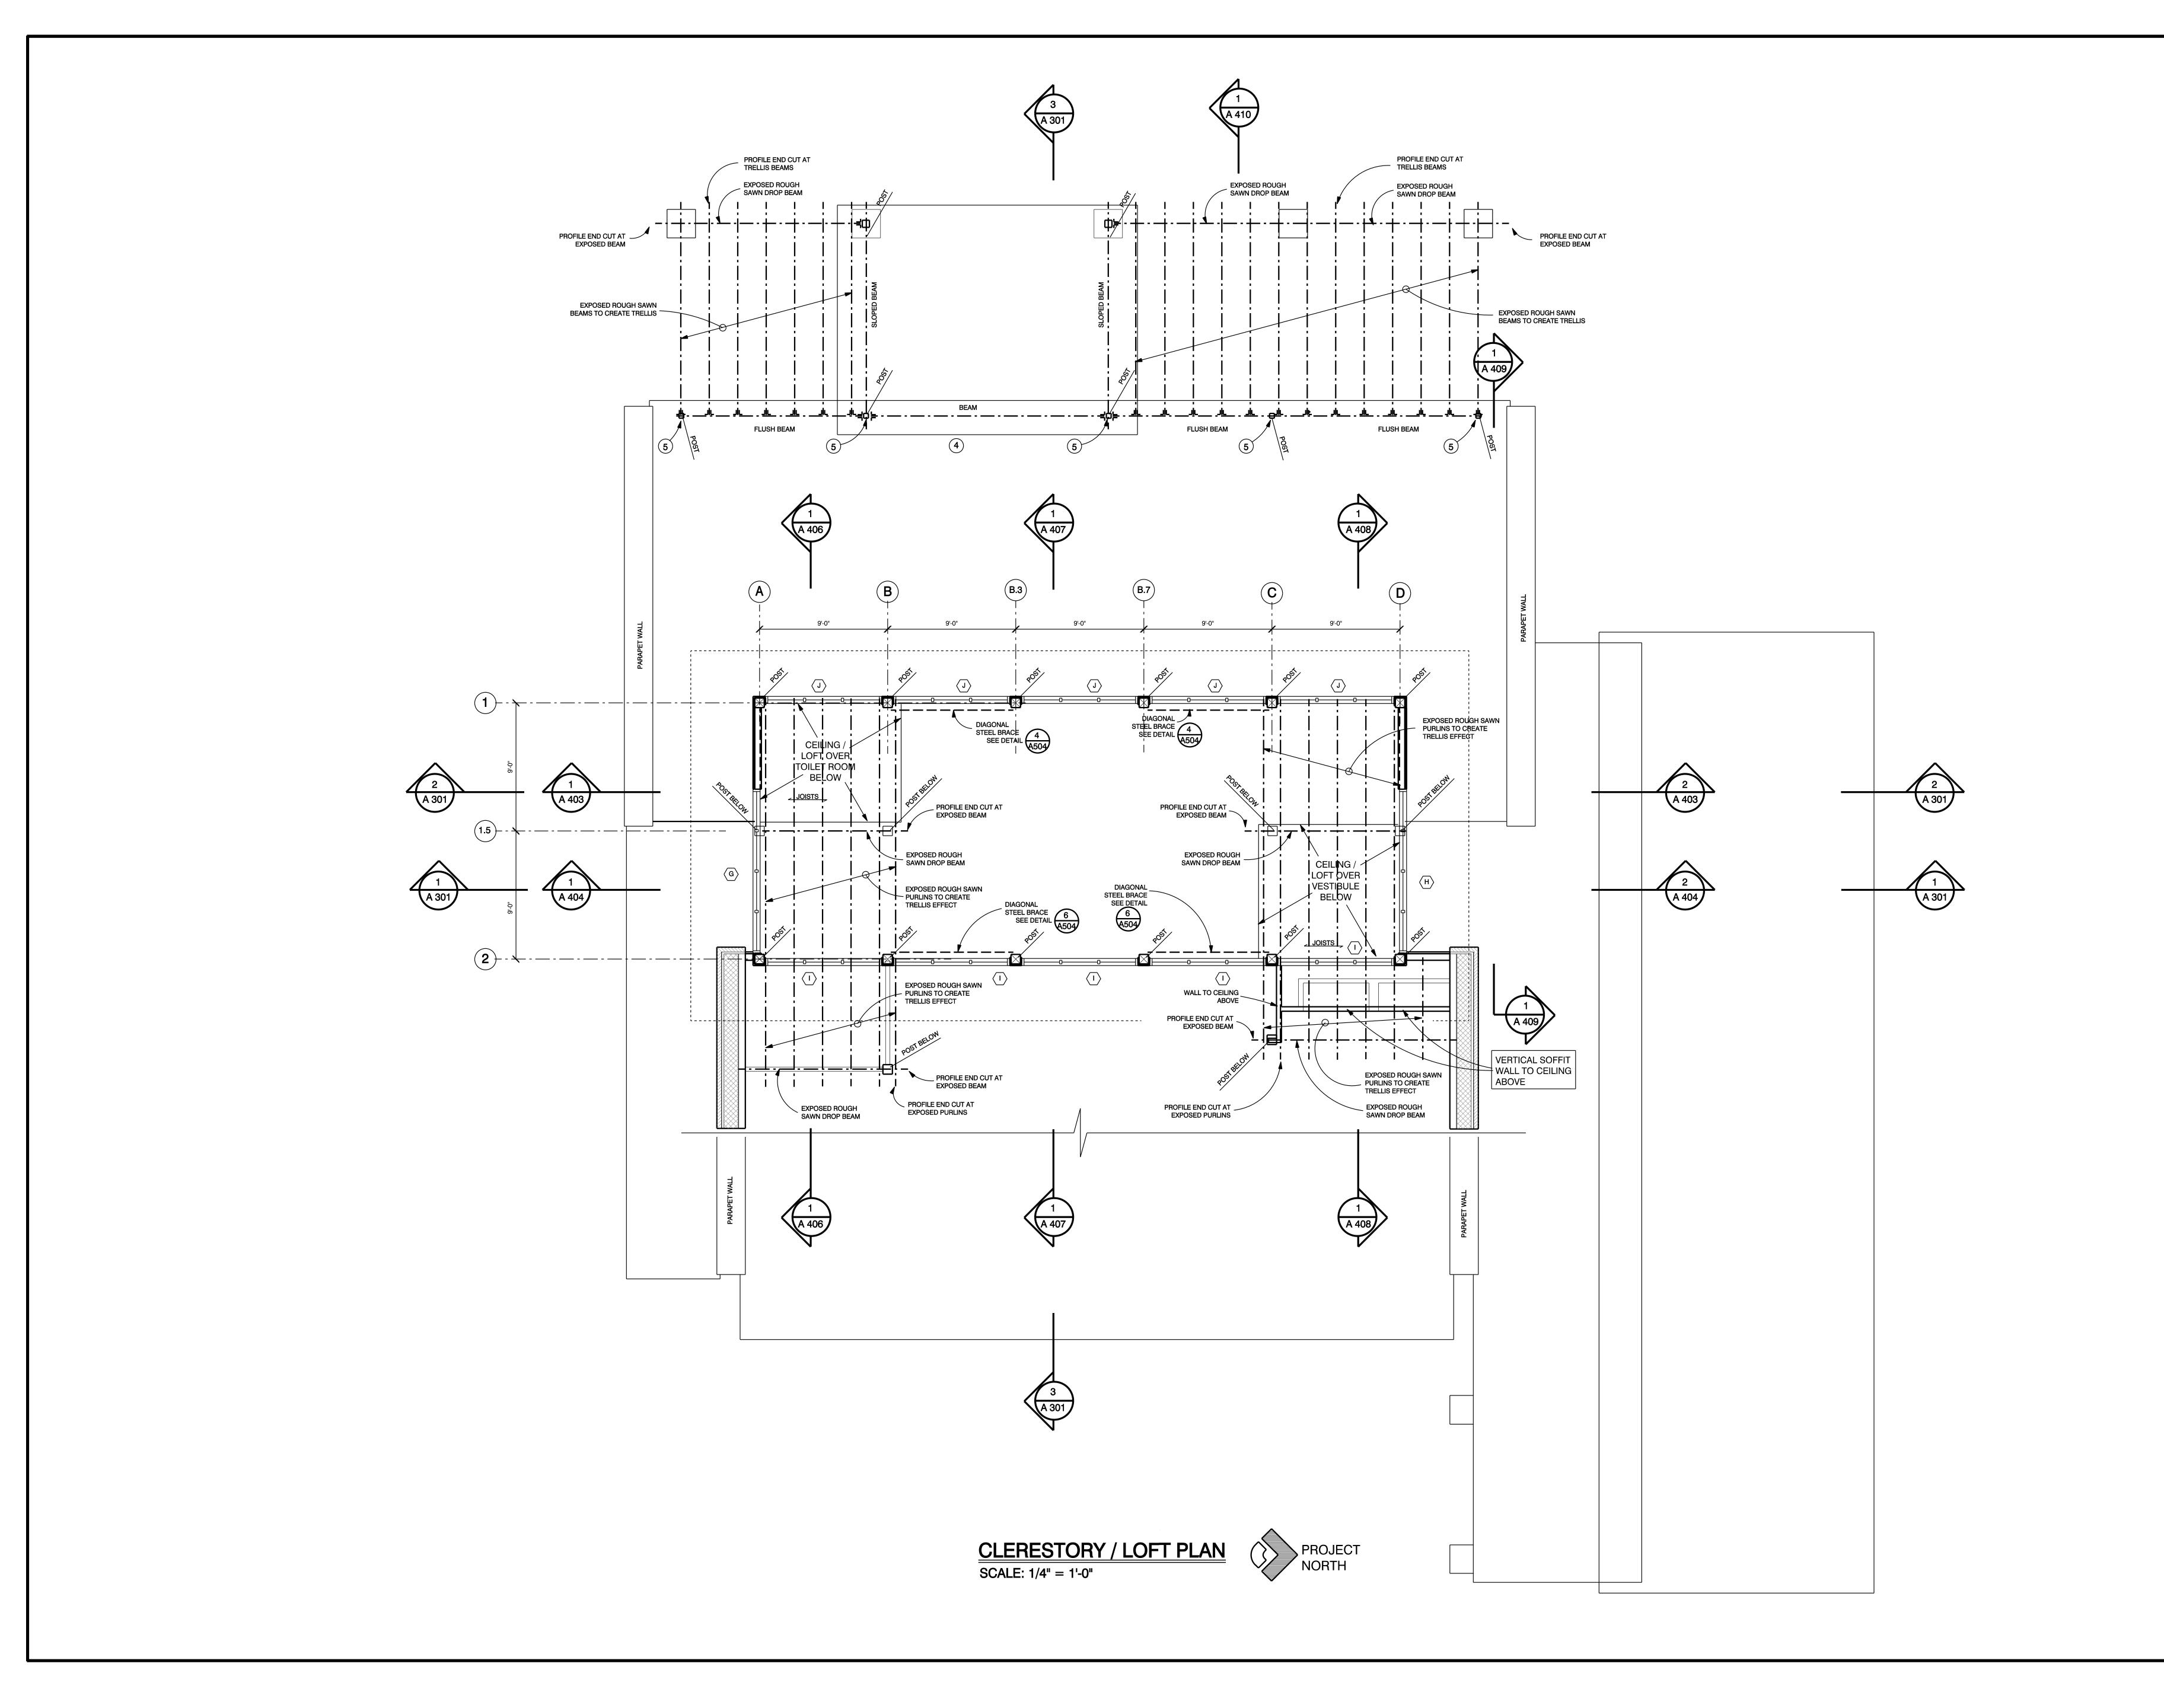


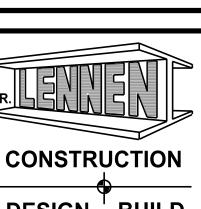
FINAL DRAWINGS 12-10-13


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CADD FOLDER BOS OAKDALE

FLOOR PLAN





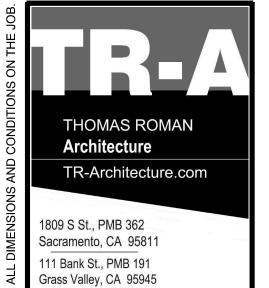

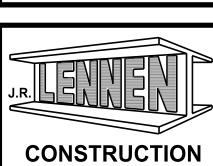
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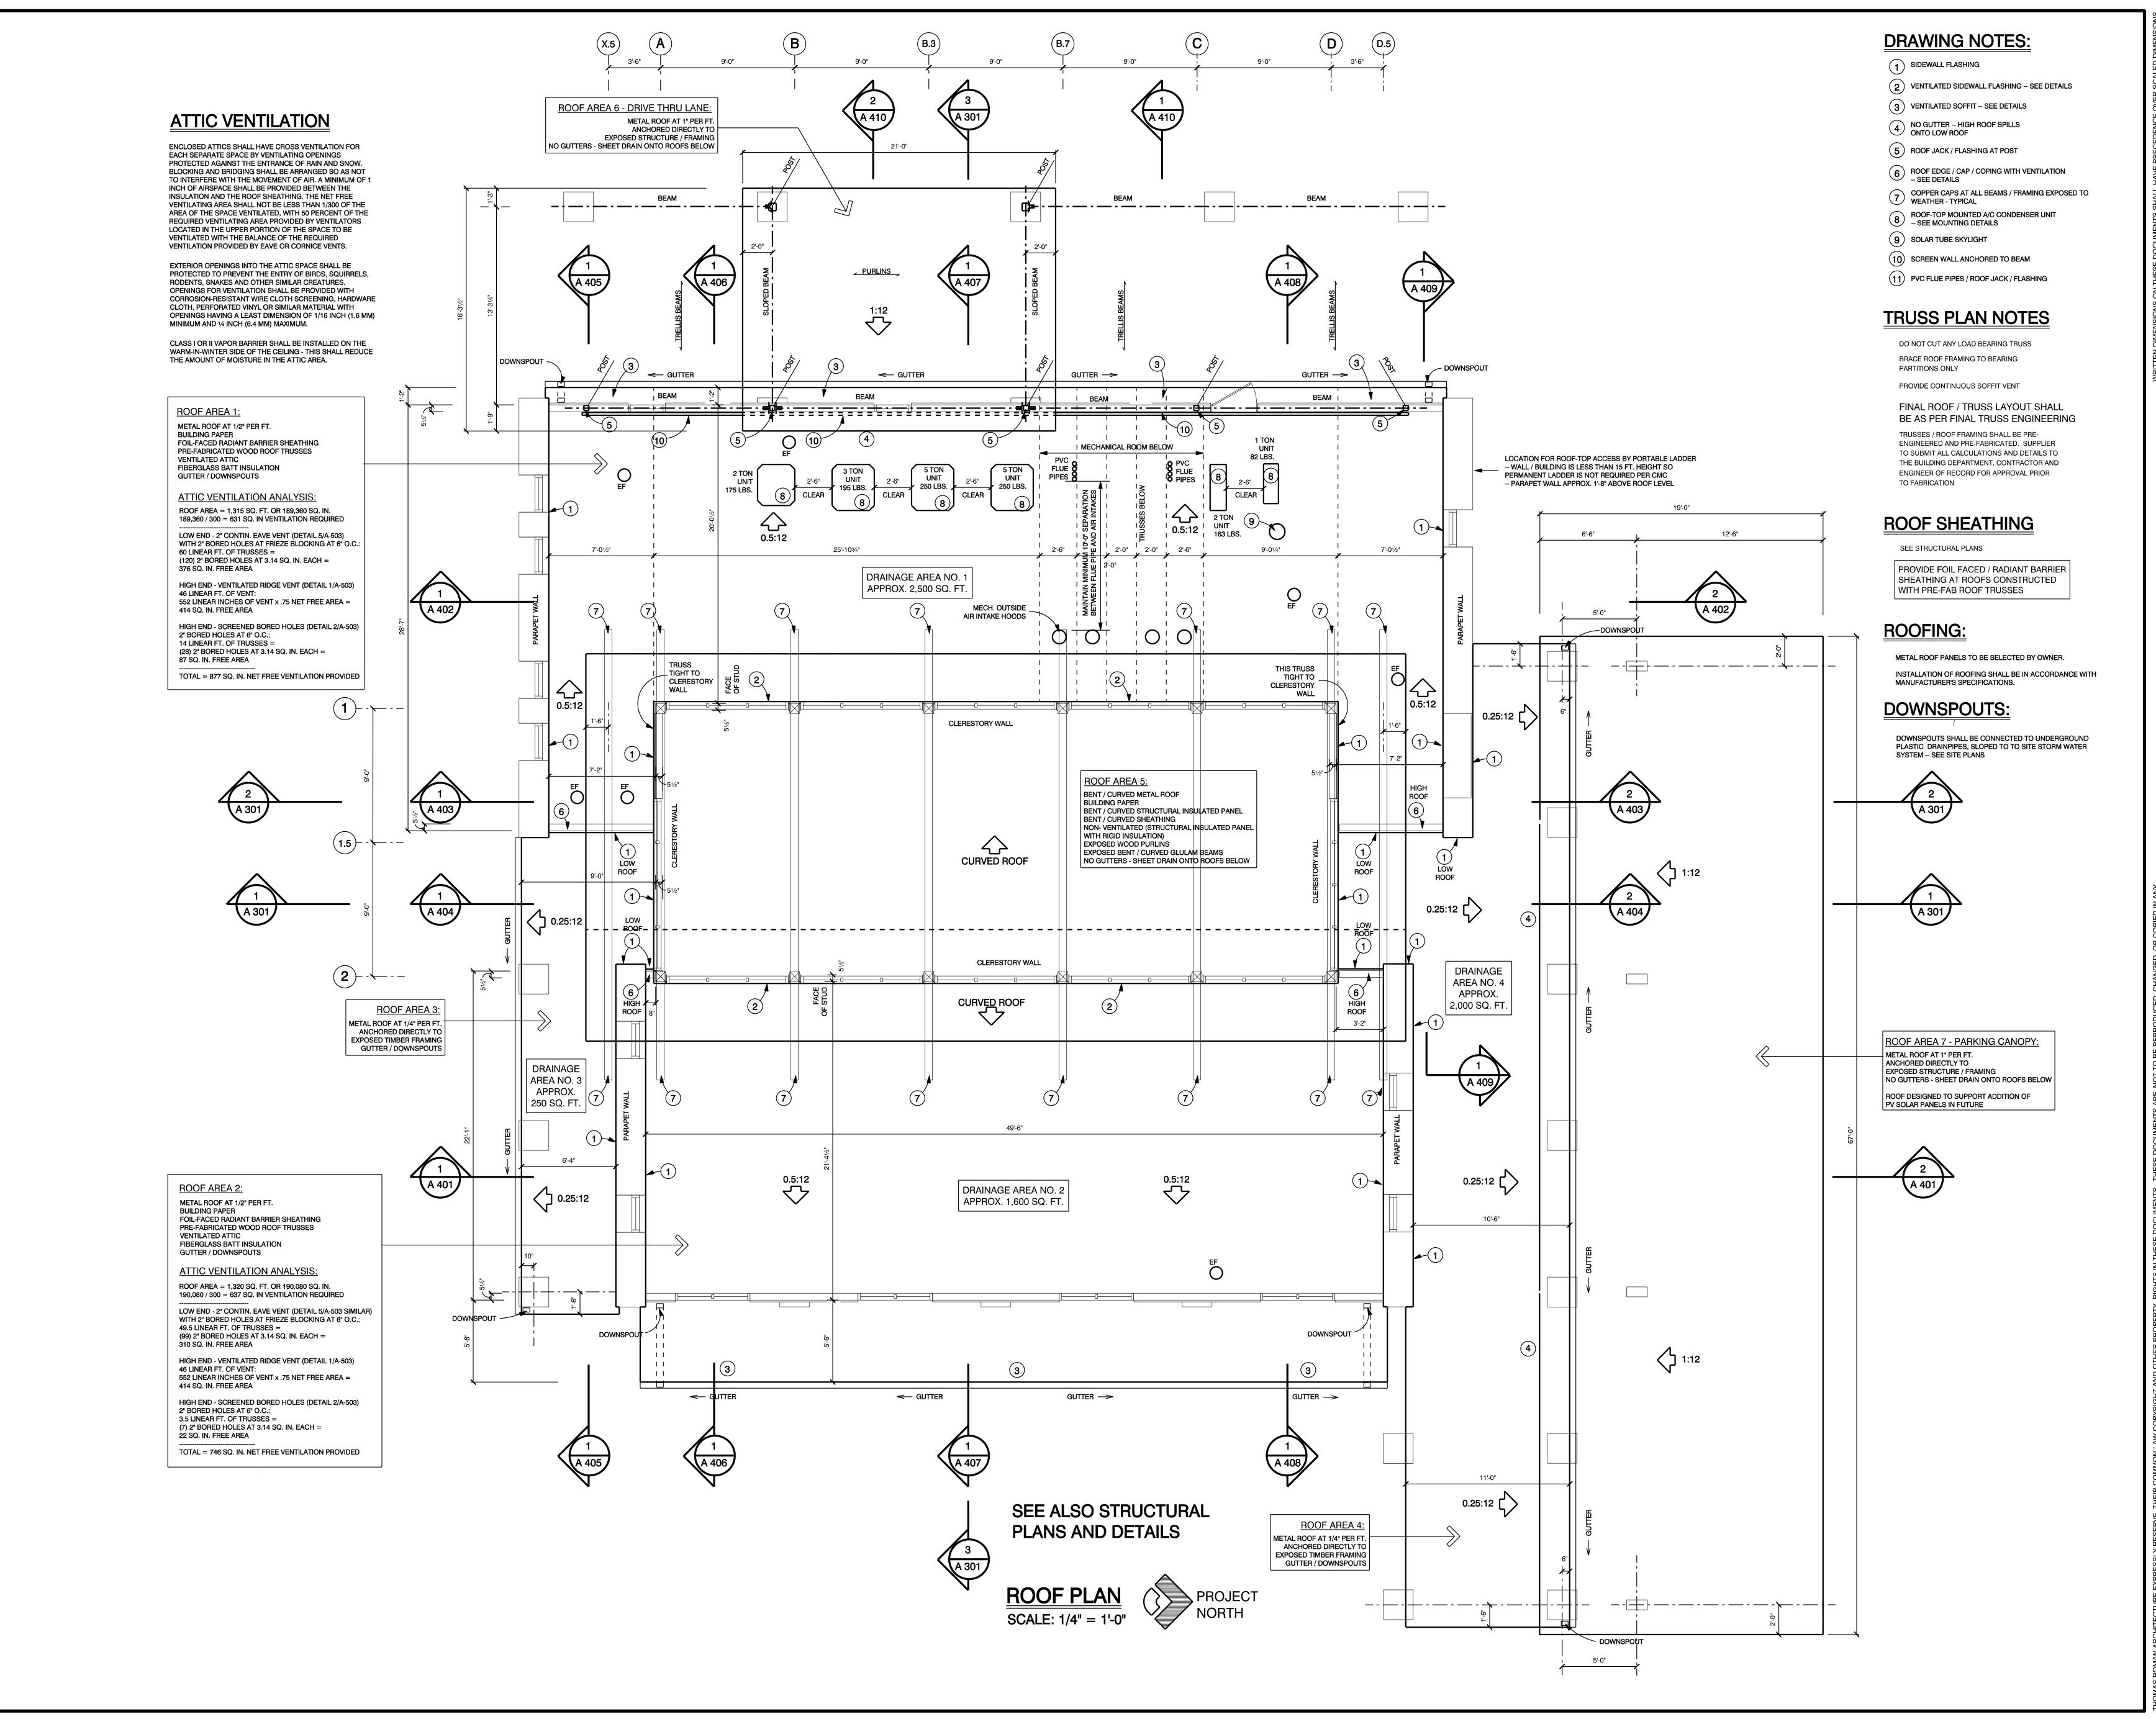
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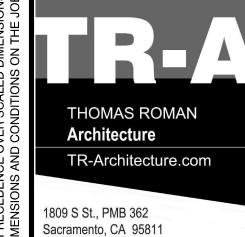
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PERMIT SET 12-10-13

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CLERESTORY /
LOFT PLAN






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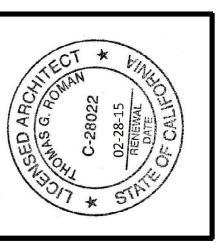

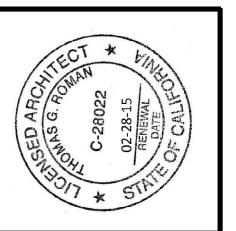
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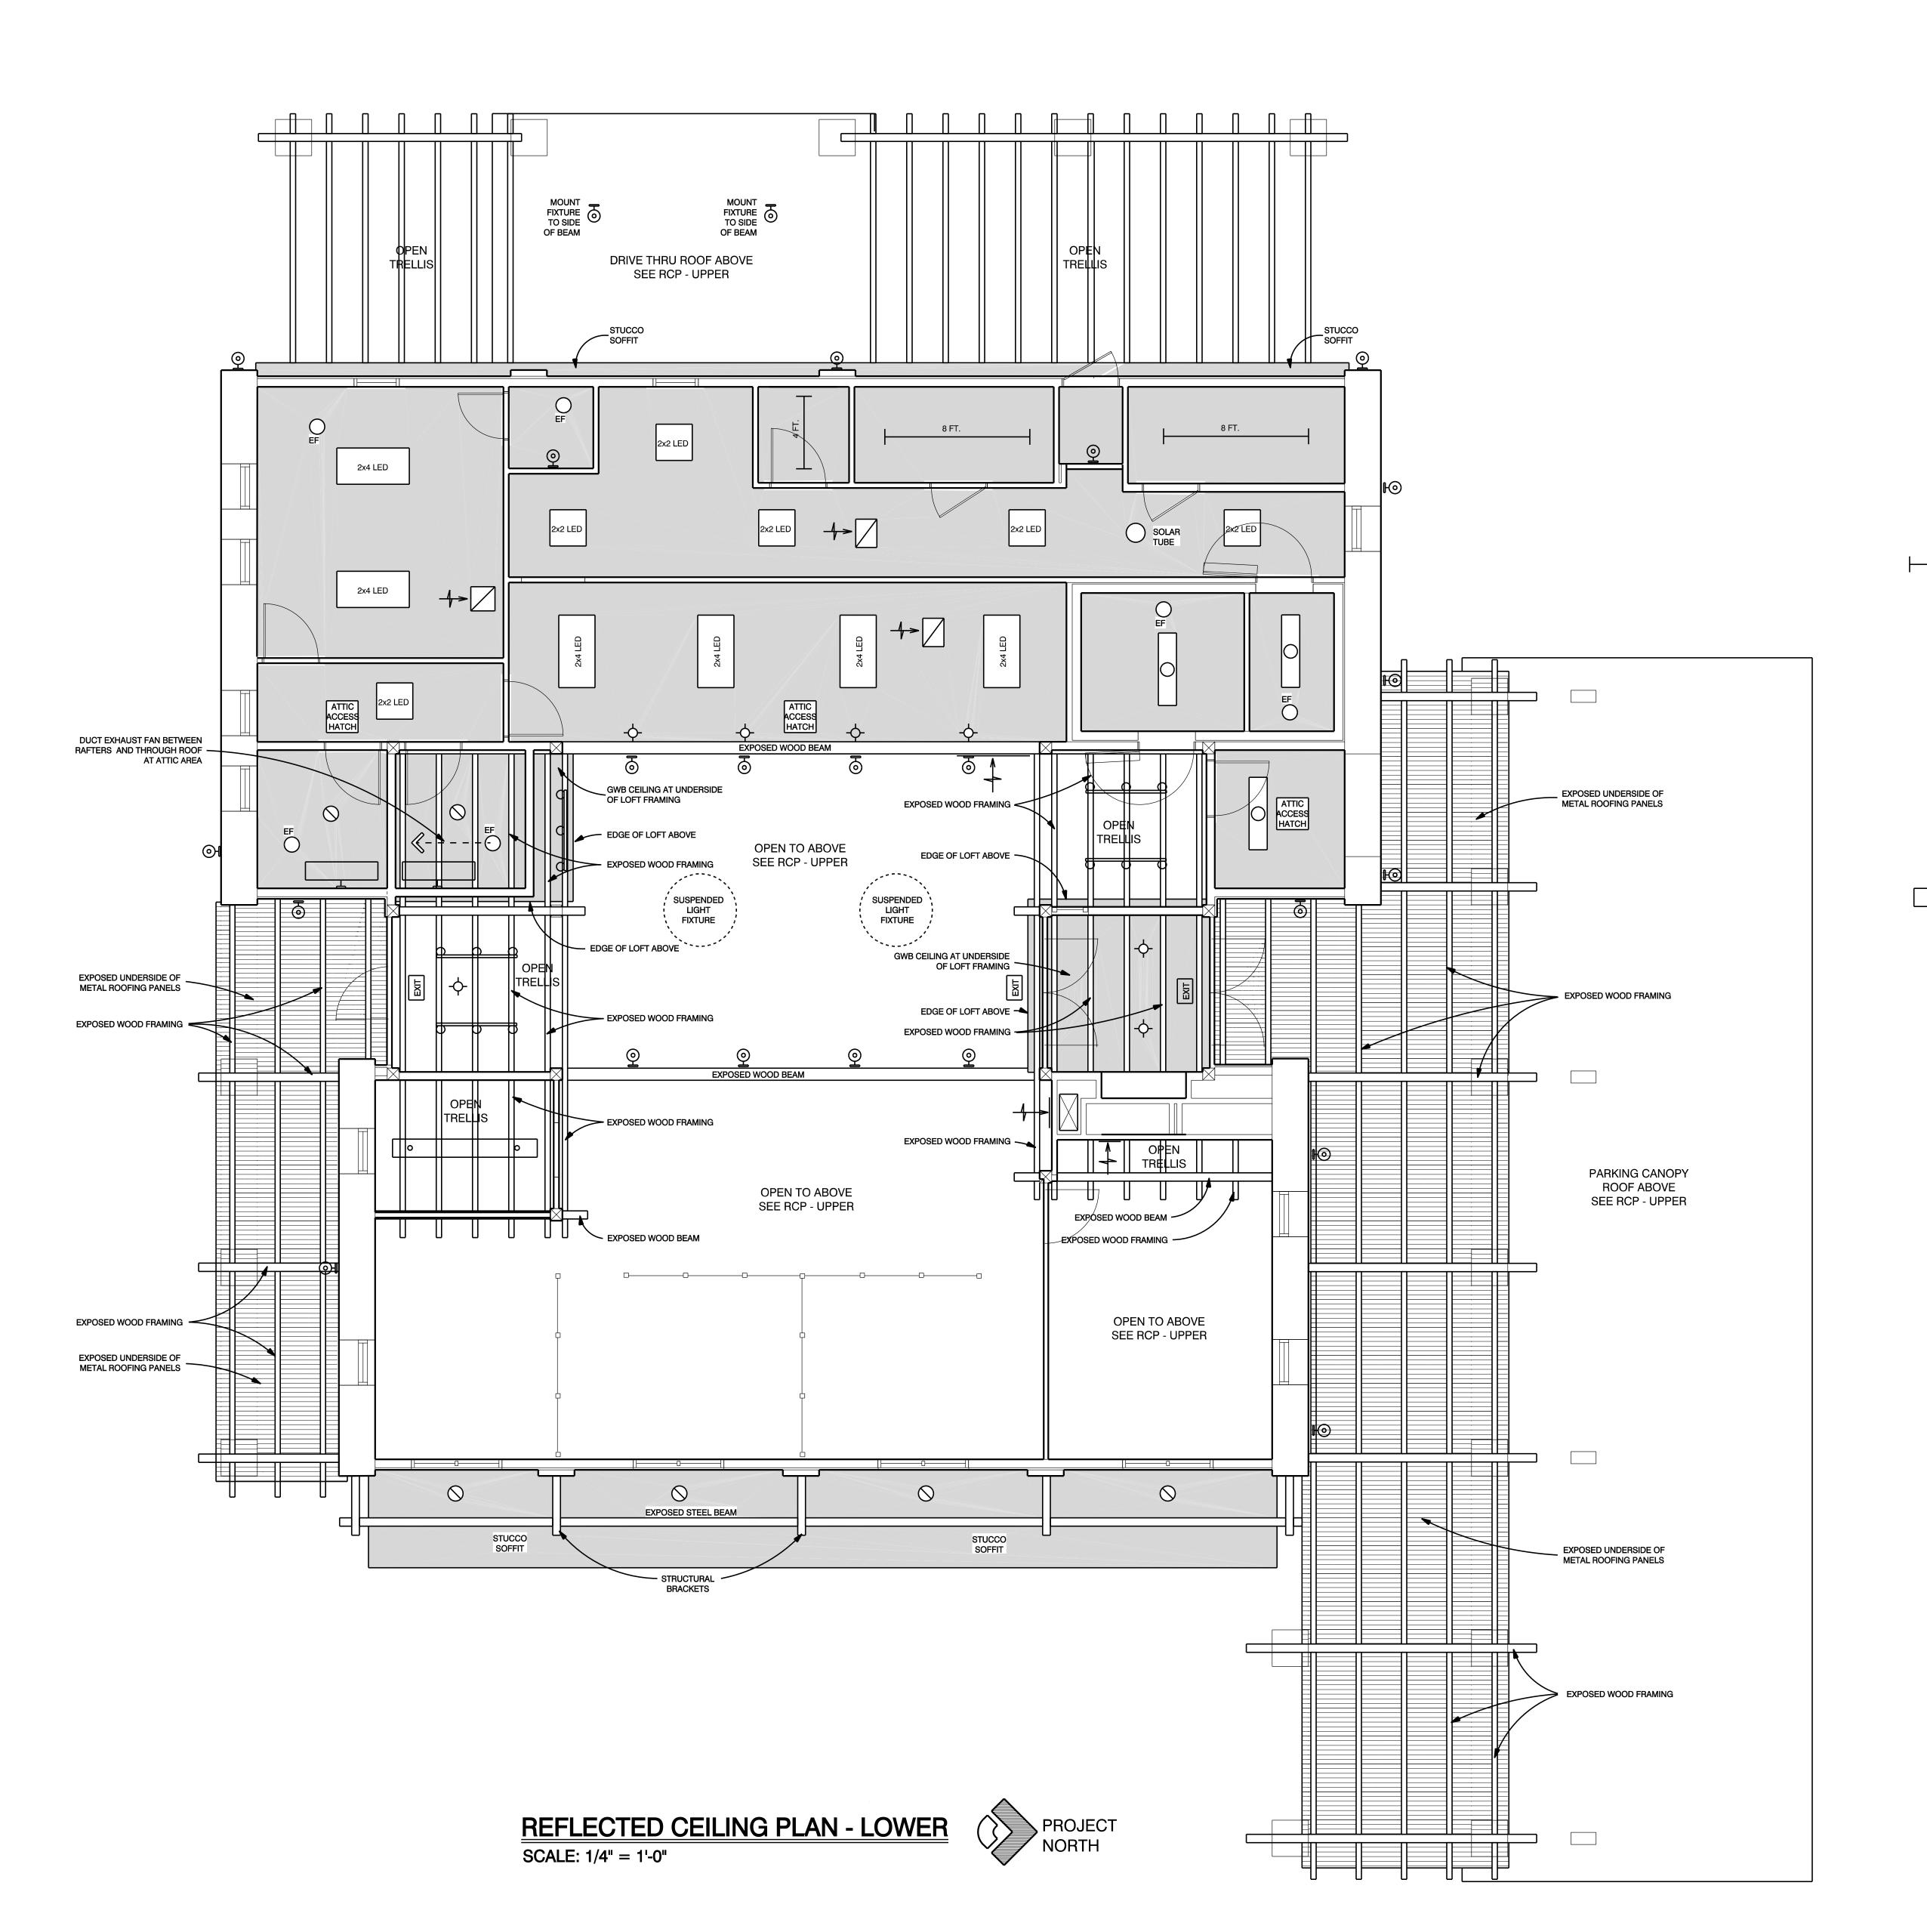
OAKDALE, CA.

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CADD FILE A 1-4
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ROOF PLAN

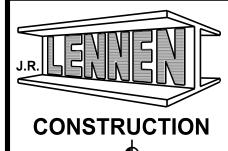

LEGEND:

GWB CEILING - SEE ALSO ROOM FINISH SCHEDULE, SHEET A-602

EXPOSED UNDERSIDE OF METAL ROOFING PANELS - SEE PLANS

EXPOSED BEAM / FRAMING MEMBER - SEE ALSO ROOM FINISH SCHEDULE, SHEET A-602

> CEILING MOUNTED MECHANICAL RETURN AIR VENT - SEE ALSO MECHANICAL PLANS

WALL MOUNTED MECHANICAL RETURN AIR VENT - SEE ALSO MECHANICAL PLANS

CEILING MOUNTED ATTIC ACCESS DOOR - DETERMINE FINAL LOCATIONS IN FIELD

CEILING EXHAUST FAN - SEE ALSO MECHANICAL PLANS

SURFACE MOUNTED LED FIXTURE - SEE ALSO ELECTRICAL PLANS

FLUORESCENT STRIP LIGHT

WALL MOUNTED LIGHT FIXTURE - SEE ALSO ELECTRICAL PLANS

- SEE ALSO ELECTRICAL PLANS SURFACE MOUNTED FLUORESCENT FIXTURE

- SEE ALSO ELECTRICAL PLANS WALL MOUNTED FLUOR. BATH BAR

- SEE ALSO ELECTRICAL PLANS DOWN LIGHT

- SEE ALSO ELECTRICAL PLANS

- SEE ALSO ELECTRICAL PLANS

- SEE ALSO ELECTRICAL PLANS


FLUORESCENT PENDENT LIGHT - SEE ALSO ELECTRICAL PLANS

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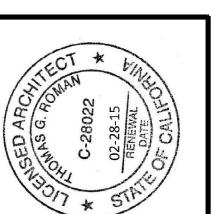


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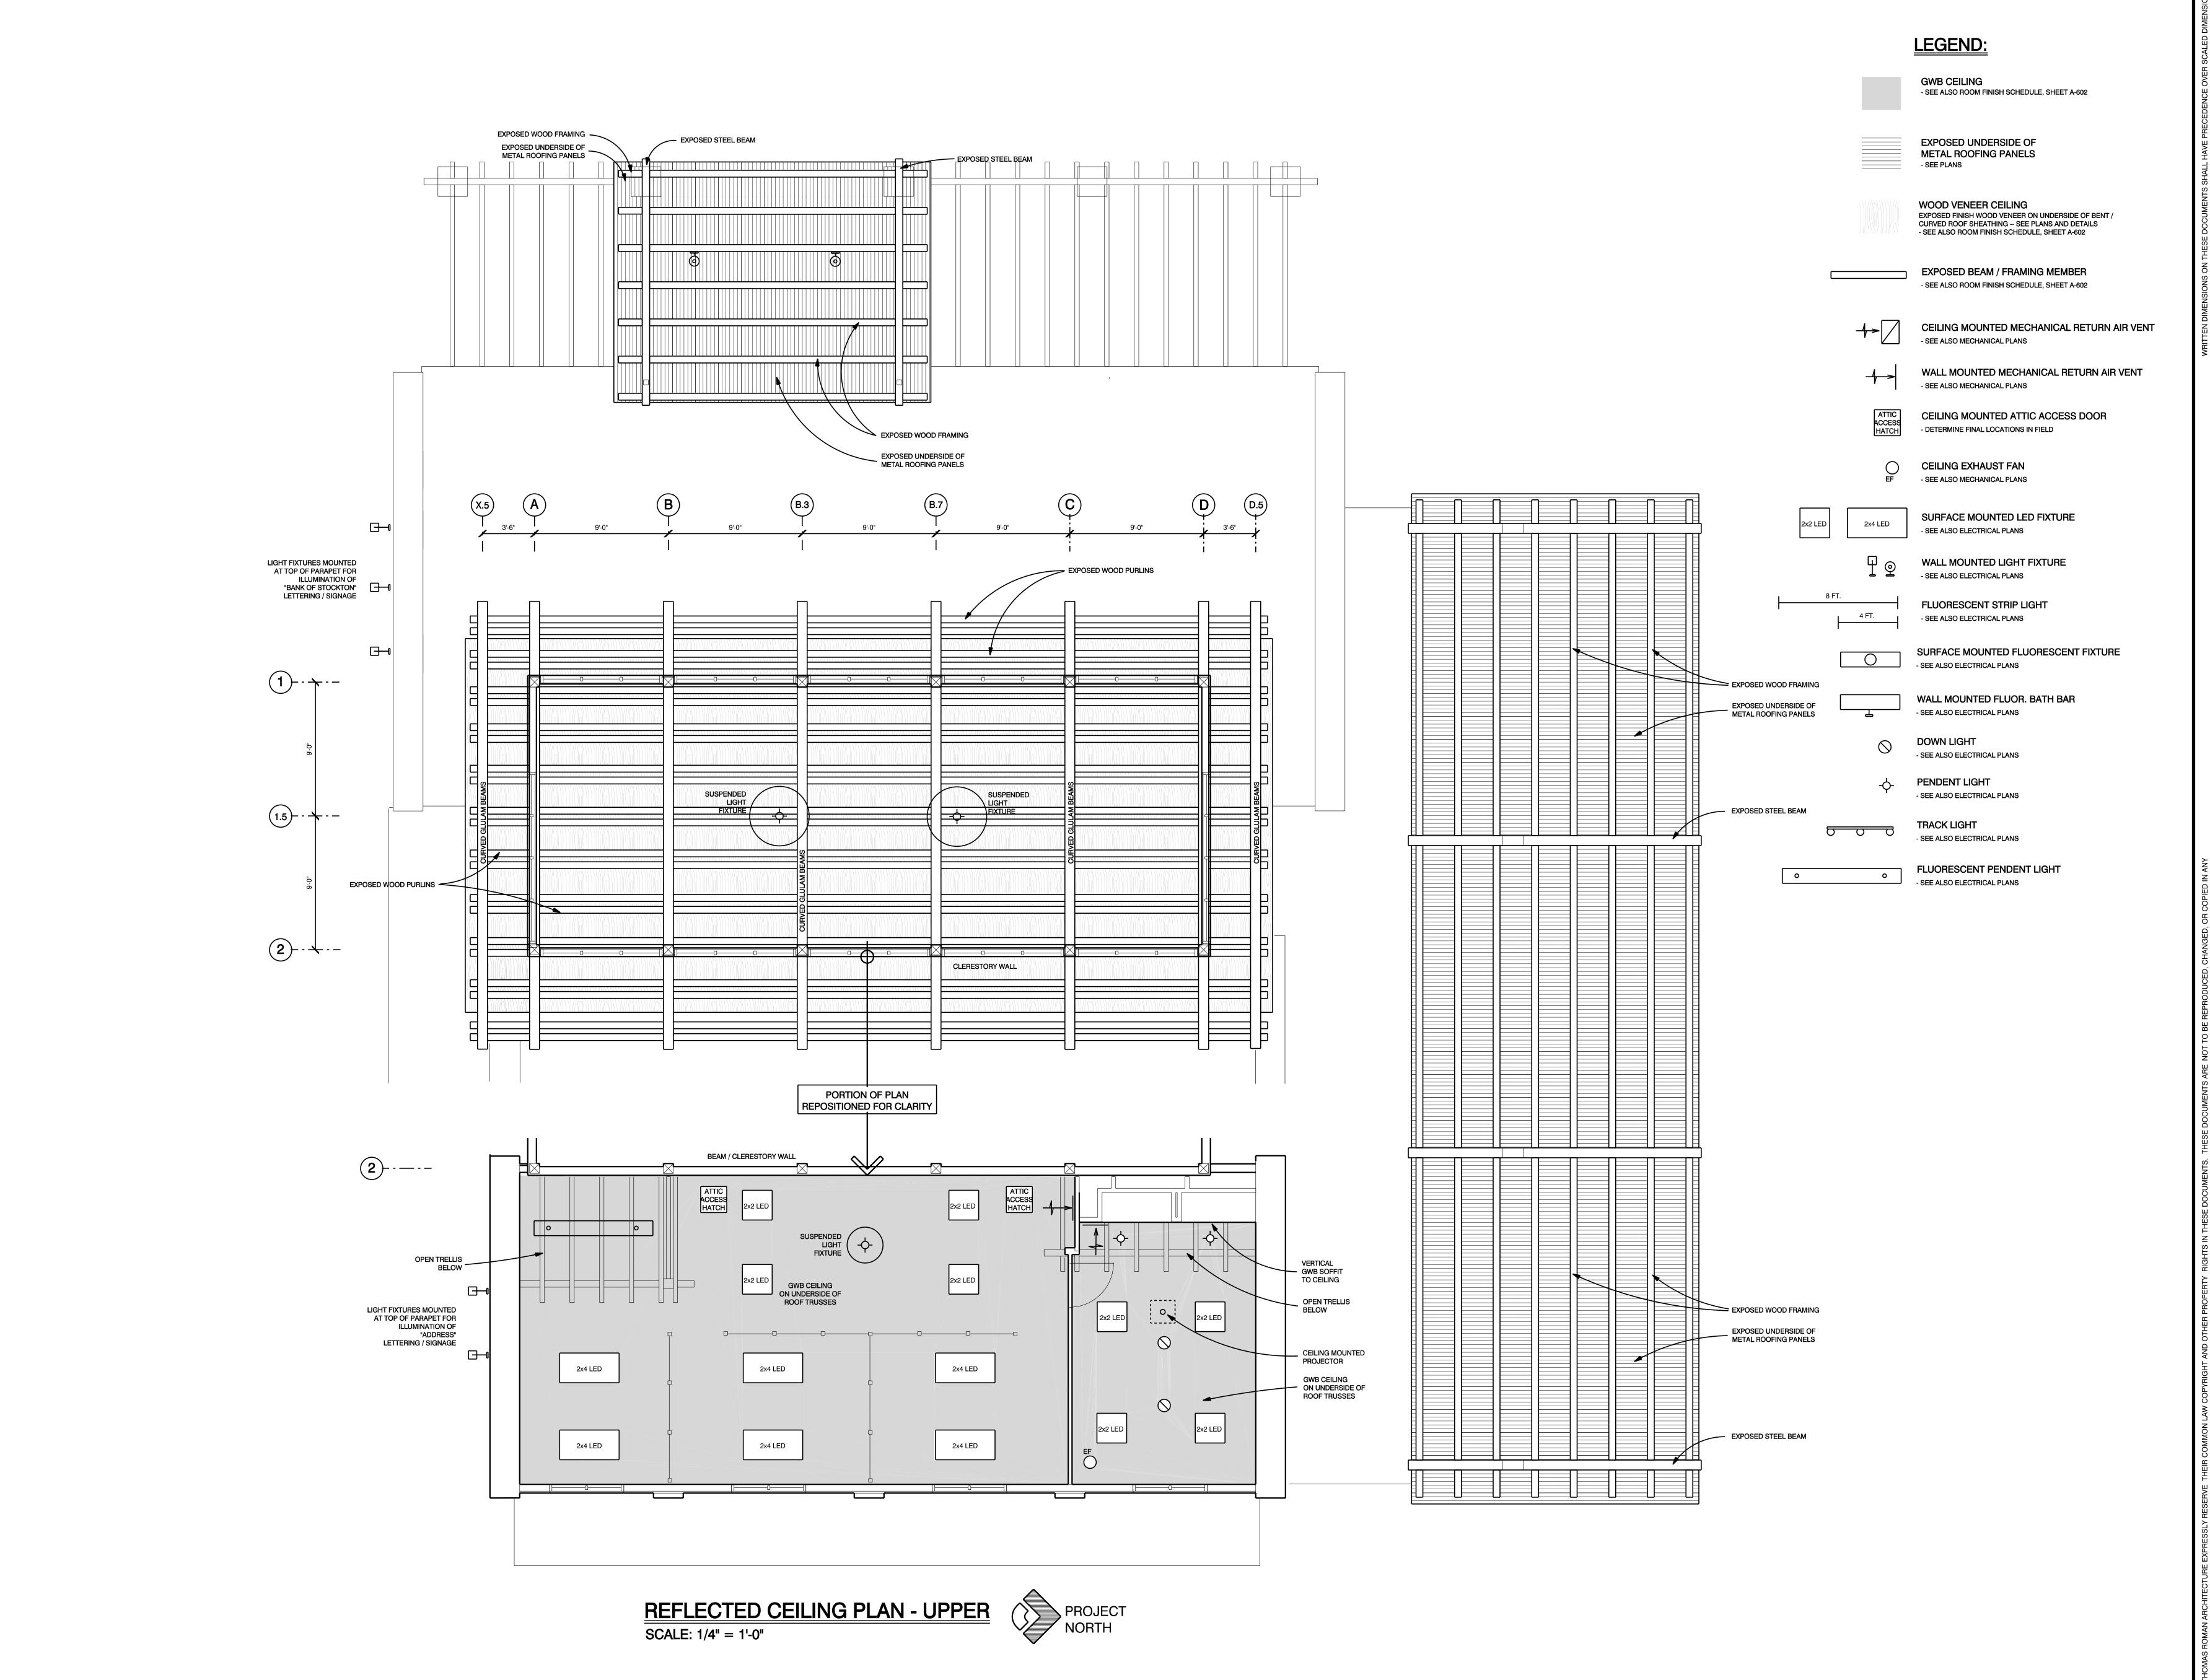


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CADD FOLDER BOS OAKDALE DRAWN BY

REFLECTED CEILING - LOWER

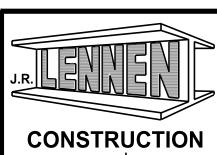

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Architecture

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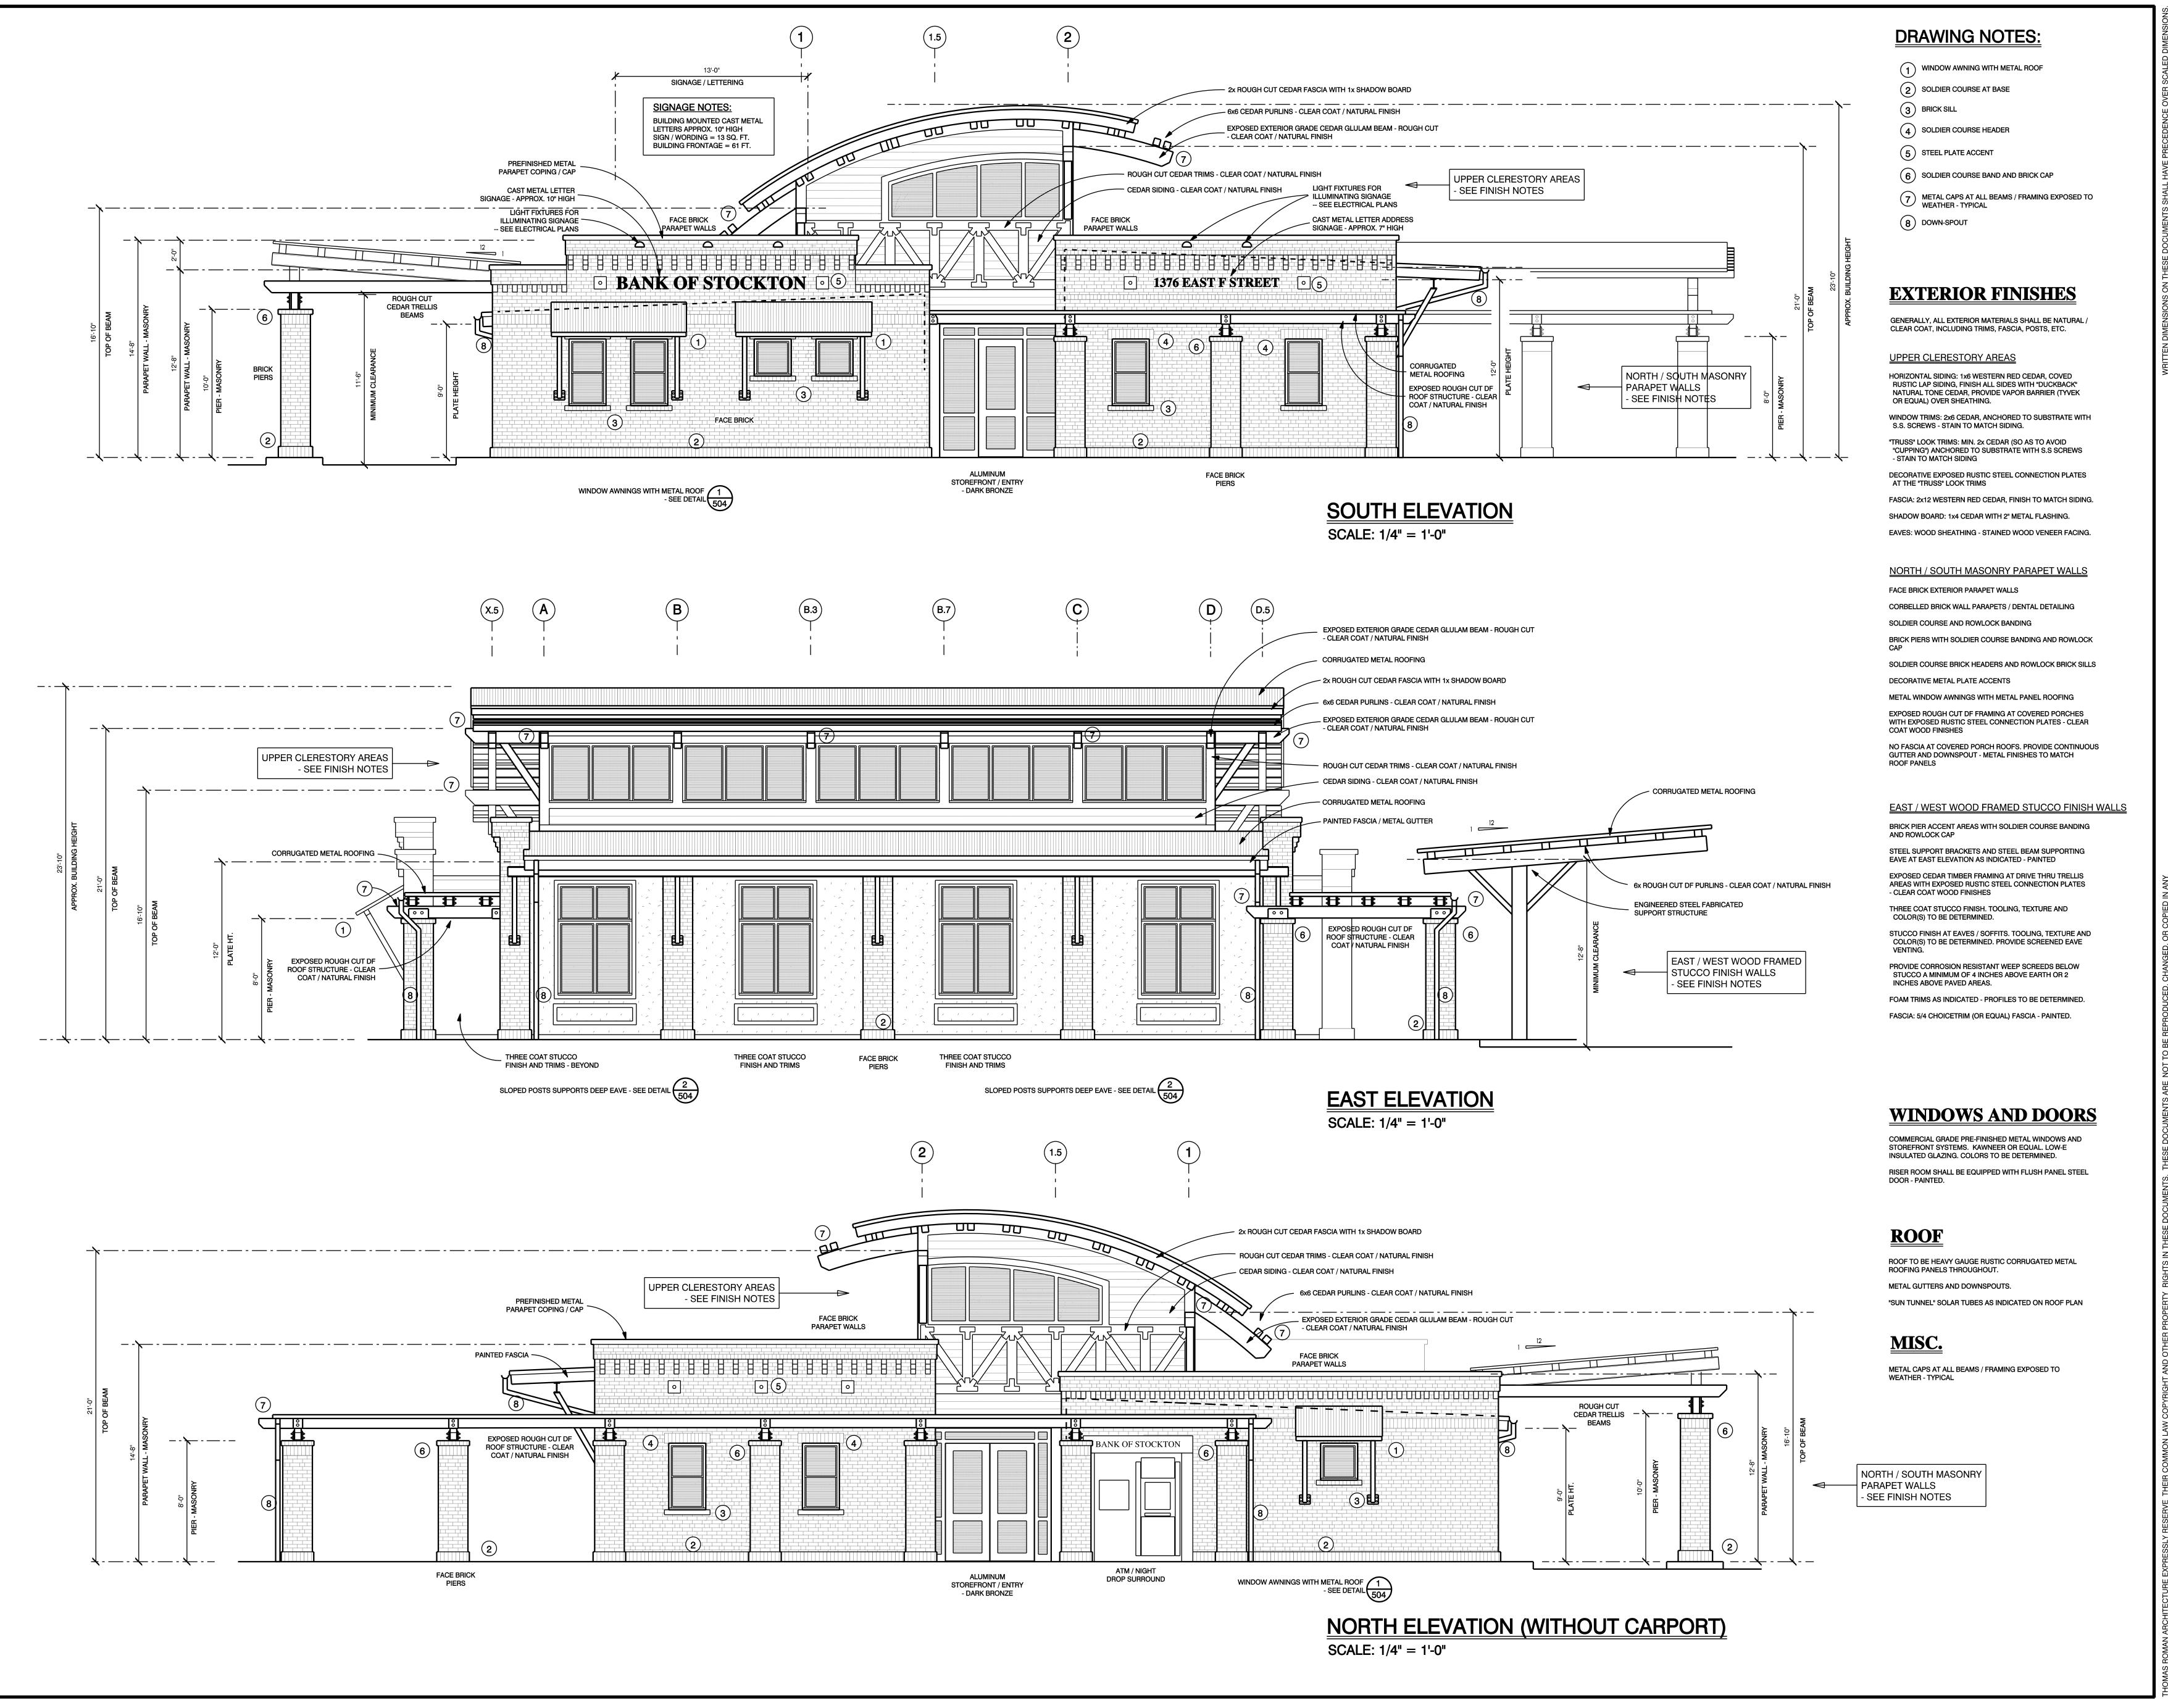
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CADD FILE A 1-6
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REFLECTED CEILING - UPPER




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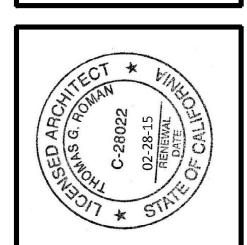


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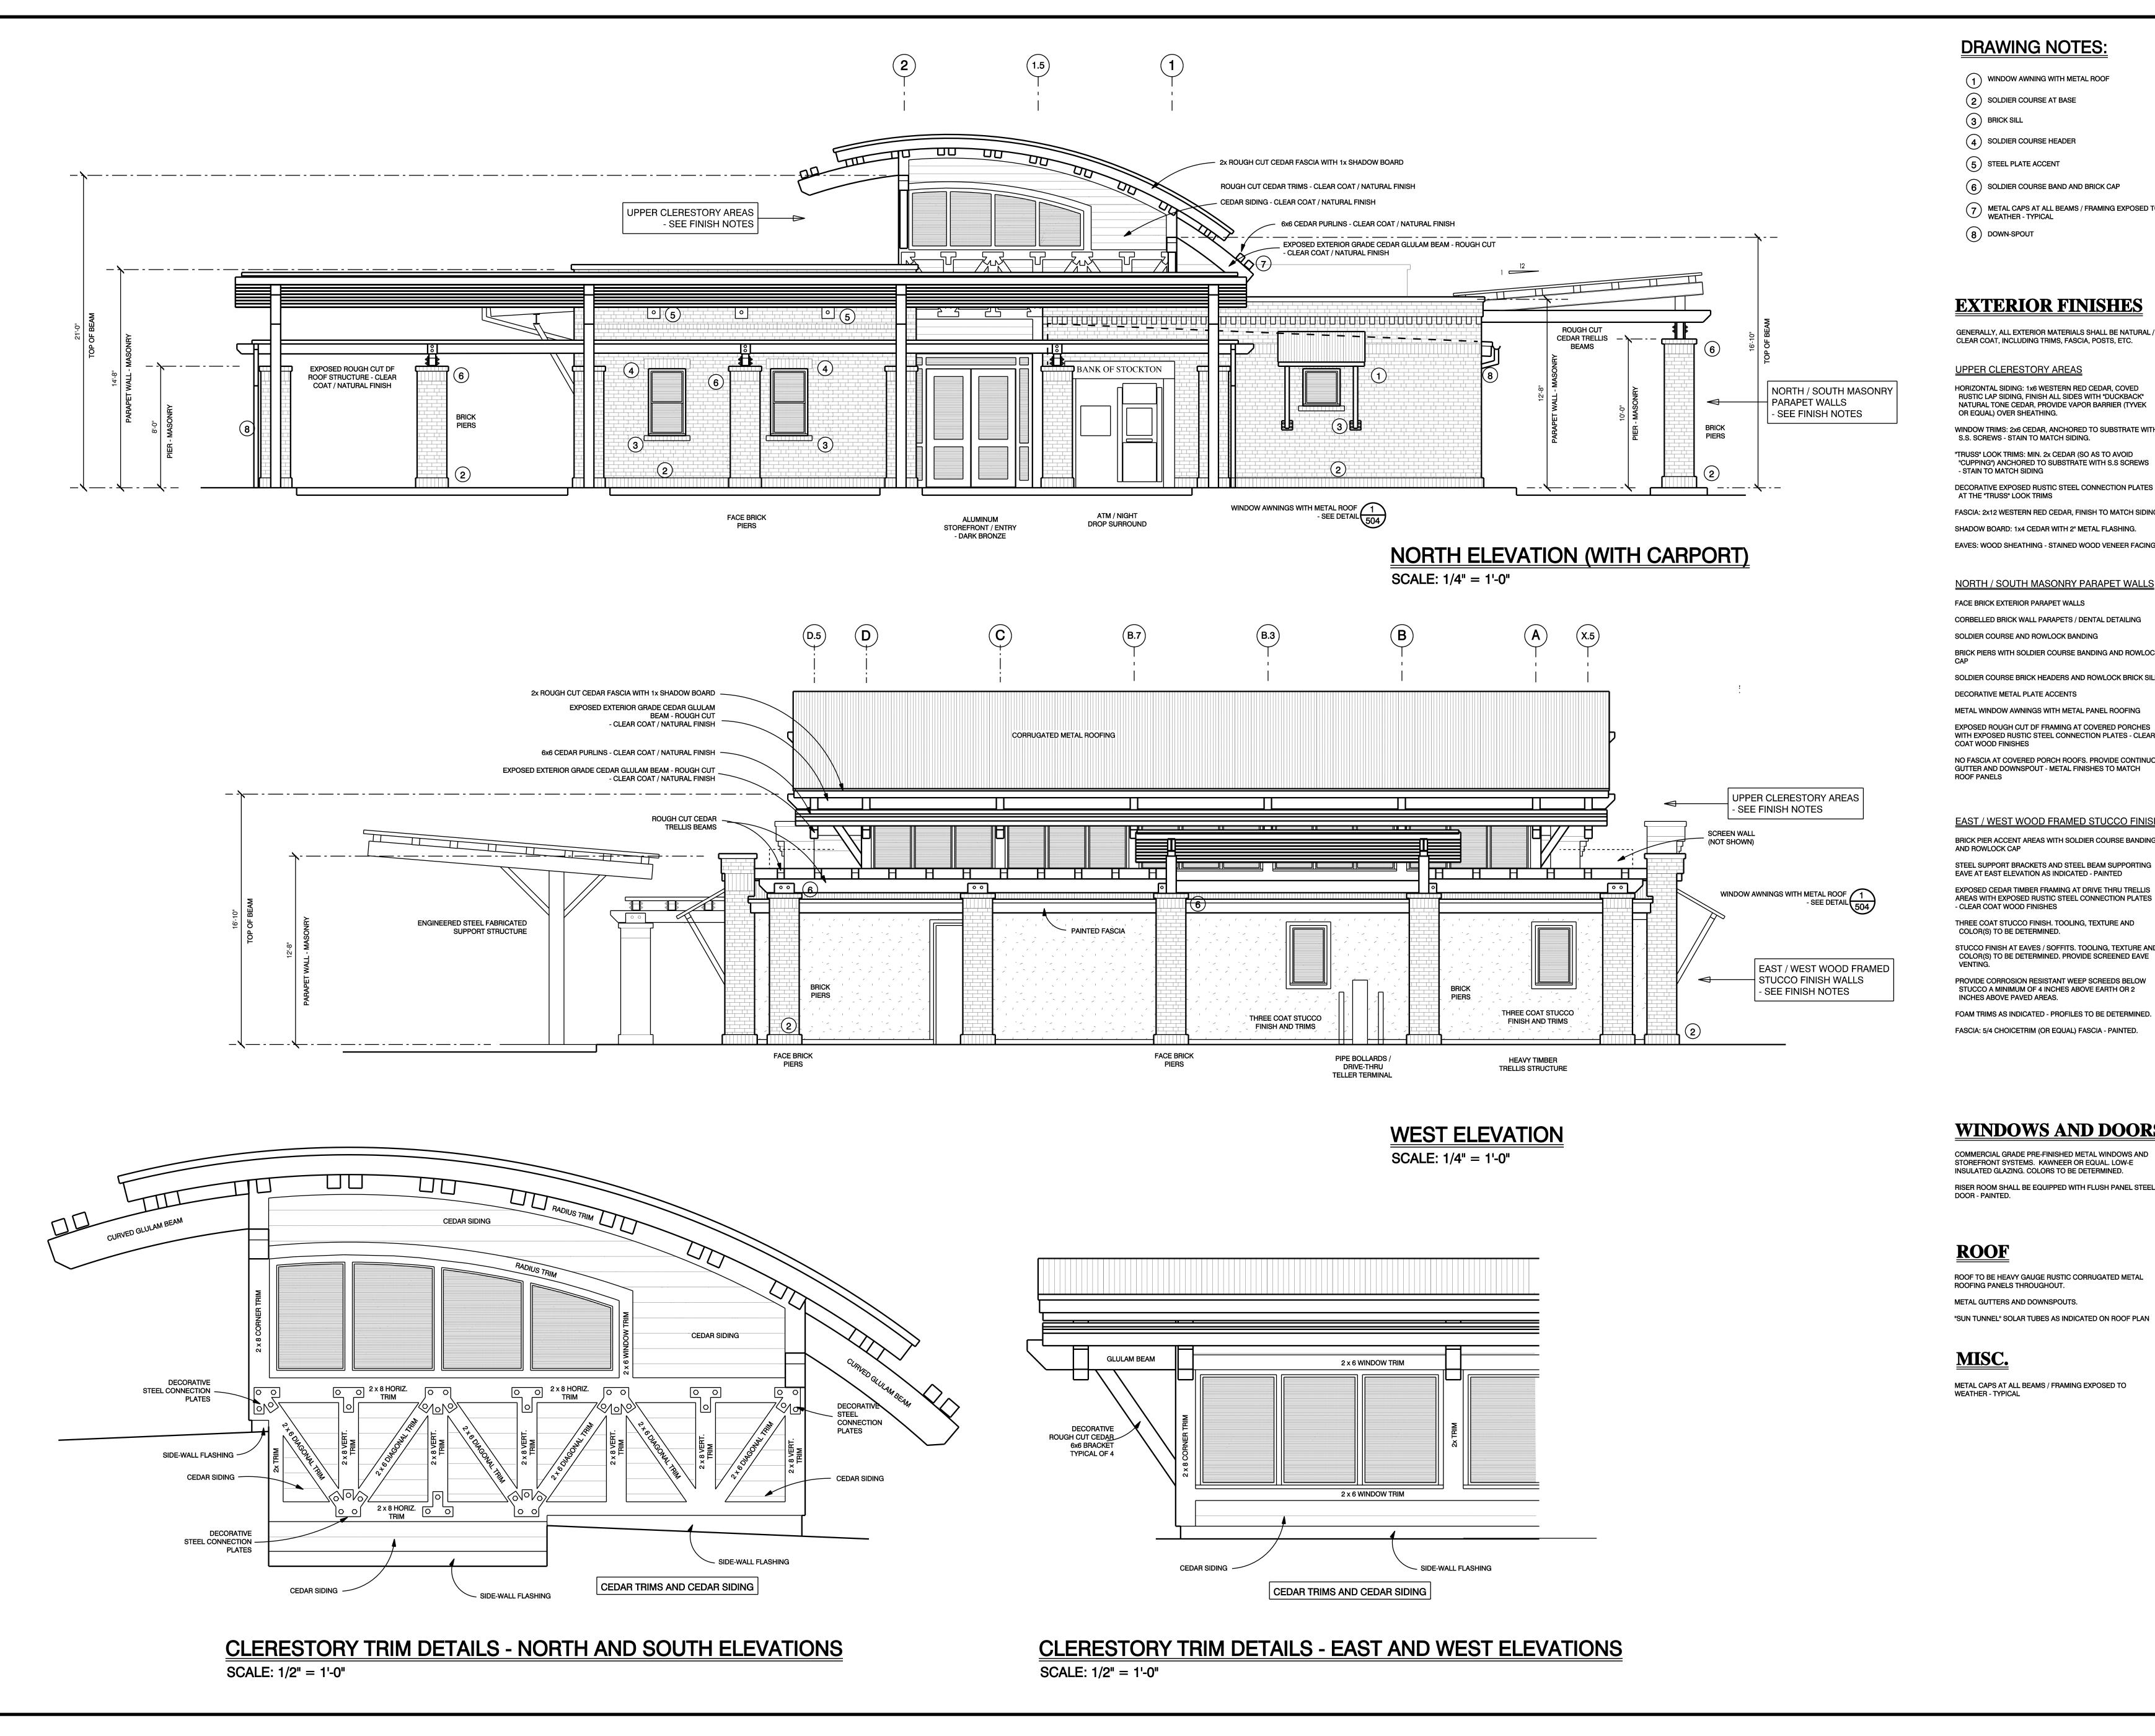
REMARKS FINAL DRAWINGS PERMIT SET 12-10-13

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ELEVATIONS

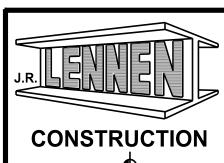

DRAWING NOTES:

- 1) WINDOW AWNING WITH METAL ROOF
- 2 SOLDIER COURSE AT BASE
- 3 BRICK SILL
- 6 SOLDIER COURSE BAND AND BRICK CAP
- 7 METAL CAPS AT ALL BEAMS / FRAMING EXPOSED TO WEATHER TYPICAL
- 8 DOWN-SPOUT

EXTERIOR FINISHES

GENERALLY, ALL EXTERIOR MATERIALS SHALL BE NATURAL / CLEAR COAT, INCLUDING TRIMS, FASCIA, POSTS, ETC.

HORIZONTAL SIDING: 1x6 WESTERN RED CEDAR, COVED RUSTIC LAP SIDING, FINISH ALL SIDES WITH "DUCKBACK" NATURAL TONE CEDAR, PROVIDE VAPOR BARRIER (TYVEK

WINDOW TRIMS: 2x6 CEDAR, ANCHORED TO SUBSTRATE WITH S.S. SCREWS - STAIN TO MATCH SIDING. "TRUSS" LOOK TRIMS: MIN. 2x CEDAR (SO AS TO AVOID

"CUPPING") ANCHORED TO SUBSTRATE WITH S.S SCREWS - STAIN TO MATCH SIDING DECORATIVE EXPOSED RUSTIC STEEL CONNECTION PLATES AT THE "TRUSS" LOOK TRIMS

FASCIA: 2x12 WESTERN RED CEDAR, FINISH TO MATCH SIDING. SHADOW BOARD: 1x4 CEDAR WITH 2" METAL FLASHING. EAVES: WOOD SHEATHING - STAINED WOOD VENEER FACING.

NORTH / SOUTH MASONRY PARAPET WALLS FACE BRICK EXTERIOR PARAPET WALLS CORBELLED BRICK WALL PARAPETS / DENTAL DETAILING SOLDIER COURSE AND ROWLOCK BANDING BRICK PIERS WITH SOLDIER COURSE BANDING AND ROWLOCK

SOLDIER COURSE BRICK HEADERS AND ROWLOCK BRICK SILLS DECORATIVE METAL PLATE ACCENTS METAL WINDOW AWNINGS WITH METAL PANEL ROOFING EXPOSED ROUGH CUT DF FRAMING AT COVERED PORCHES WITH EXPOSED RUSTIC STEEL CONNECTION PLATES - CLEAR COAT WOOD FINISHES

NO FASCIA AT COVERED PORCH ROOFS. PROVIDE CONTINUOUS GUTTER AND DOWNSPOUT - METAL FINISHES TO MATCH ROOF PANELS

EAST / WEST WOOD FRAMED STUCCO FINISH WALLS BRICK PIER ACCENT AREAS WITH SOLDIER COURSE BANDING AND ROWLOCK CAP

STEEL SUPPORT BRACKETS AND STEEL BEAM SUPPORTING EAVE AT EAST ELEVATION AS INDICATED - PAINTED EXPOSED CEDAR TIMBER FRAMING AT DRIVE THRU TRELLIS

- CLEAR COAT WOOD FINISHES THREE COAT STUCCO FINISH. TOOLING, TEXTURE AND COLOR(S) TO BE DETERMINED.

STUCCO FINISH AT EAVES / SOFFITS. TOOLING, TEXTURE AND COLOR(S) TO BE DETERMINED. PROVIDE SCREENED EAVE PROVIDE CORROSION RESISTANT WEEP SCREEDS BELOW

STUCCO A MINIMUM OF 4 INCHES ABOVE EARTH OR 2 INCHES ABOVE PAVED AREAS. FOAM TRIMS AS INDICATED - PROFILES TO BE DETERMINED. FASCIA: 5/4 CHOICETRIM (OR EQUAL) FASCIA - PAINTED.

WINDOWS AND DOORS

COMMERCIAL GRADE PRE-FINISHED METAL WINDOWS AND STOREFRONT SYSTEMS. KAWNEER OR EQUAL. LOW-E INSULATED GLAZING. COLORS TO BE DETERMINED. RISER ROOM SHALL BE EQUIPPED WITH FLUSH PANEL STEEL


ROOF TO BE HEAVY GAUGE RUSTIC CORRUGATED METAL ROOFING PANELS THROUGHOUT. METAL GUTTERS AND DOWNSPOUTS.

METAL CAPS AT ALL BEAMS / FRAMING EXPOSED TO WEATHER - TYPICAL



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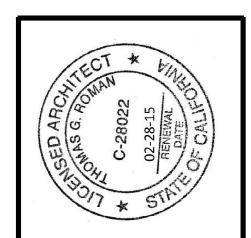
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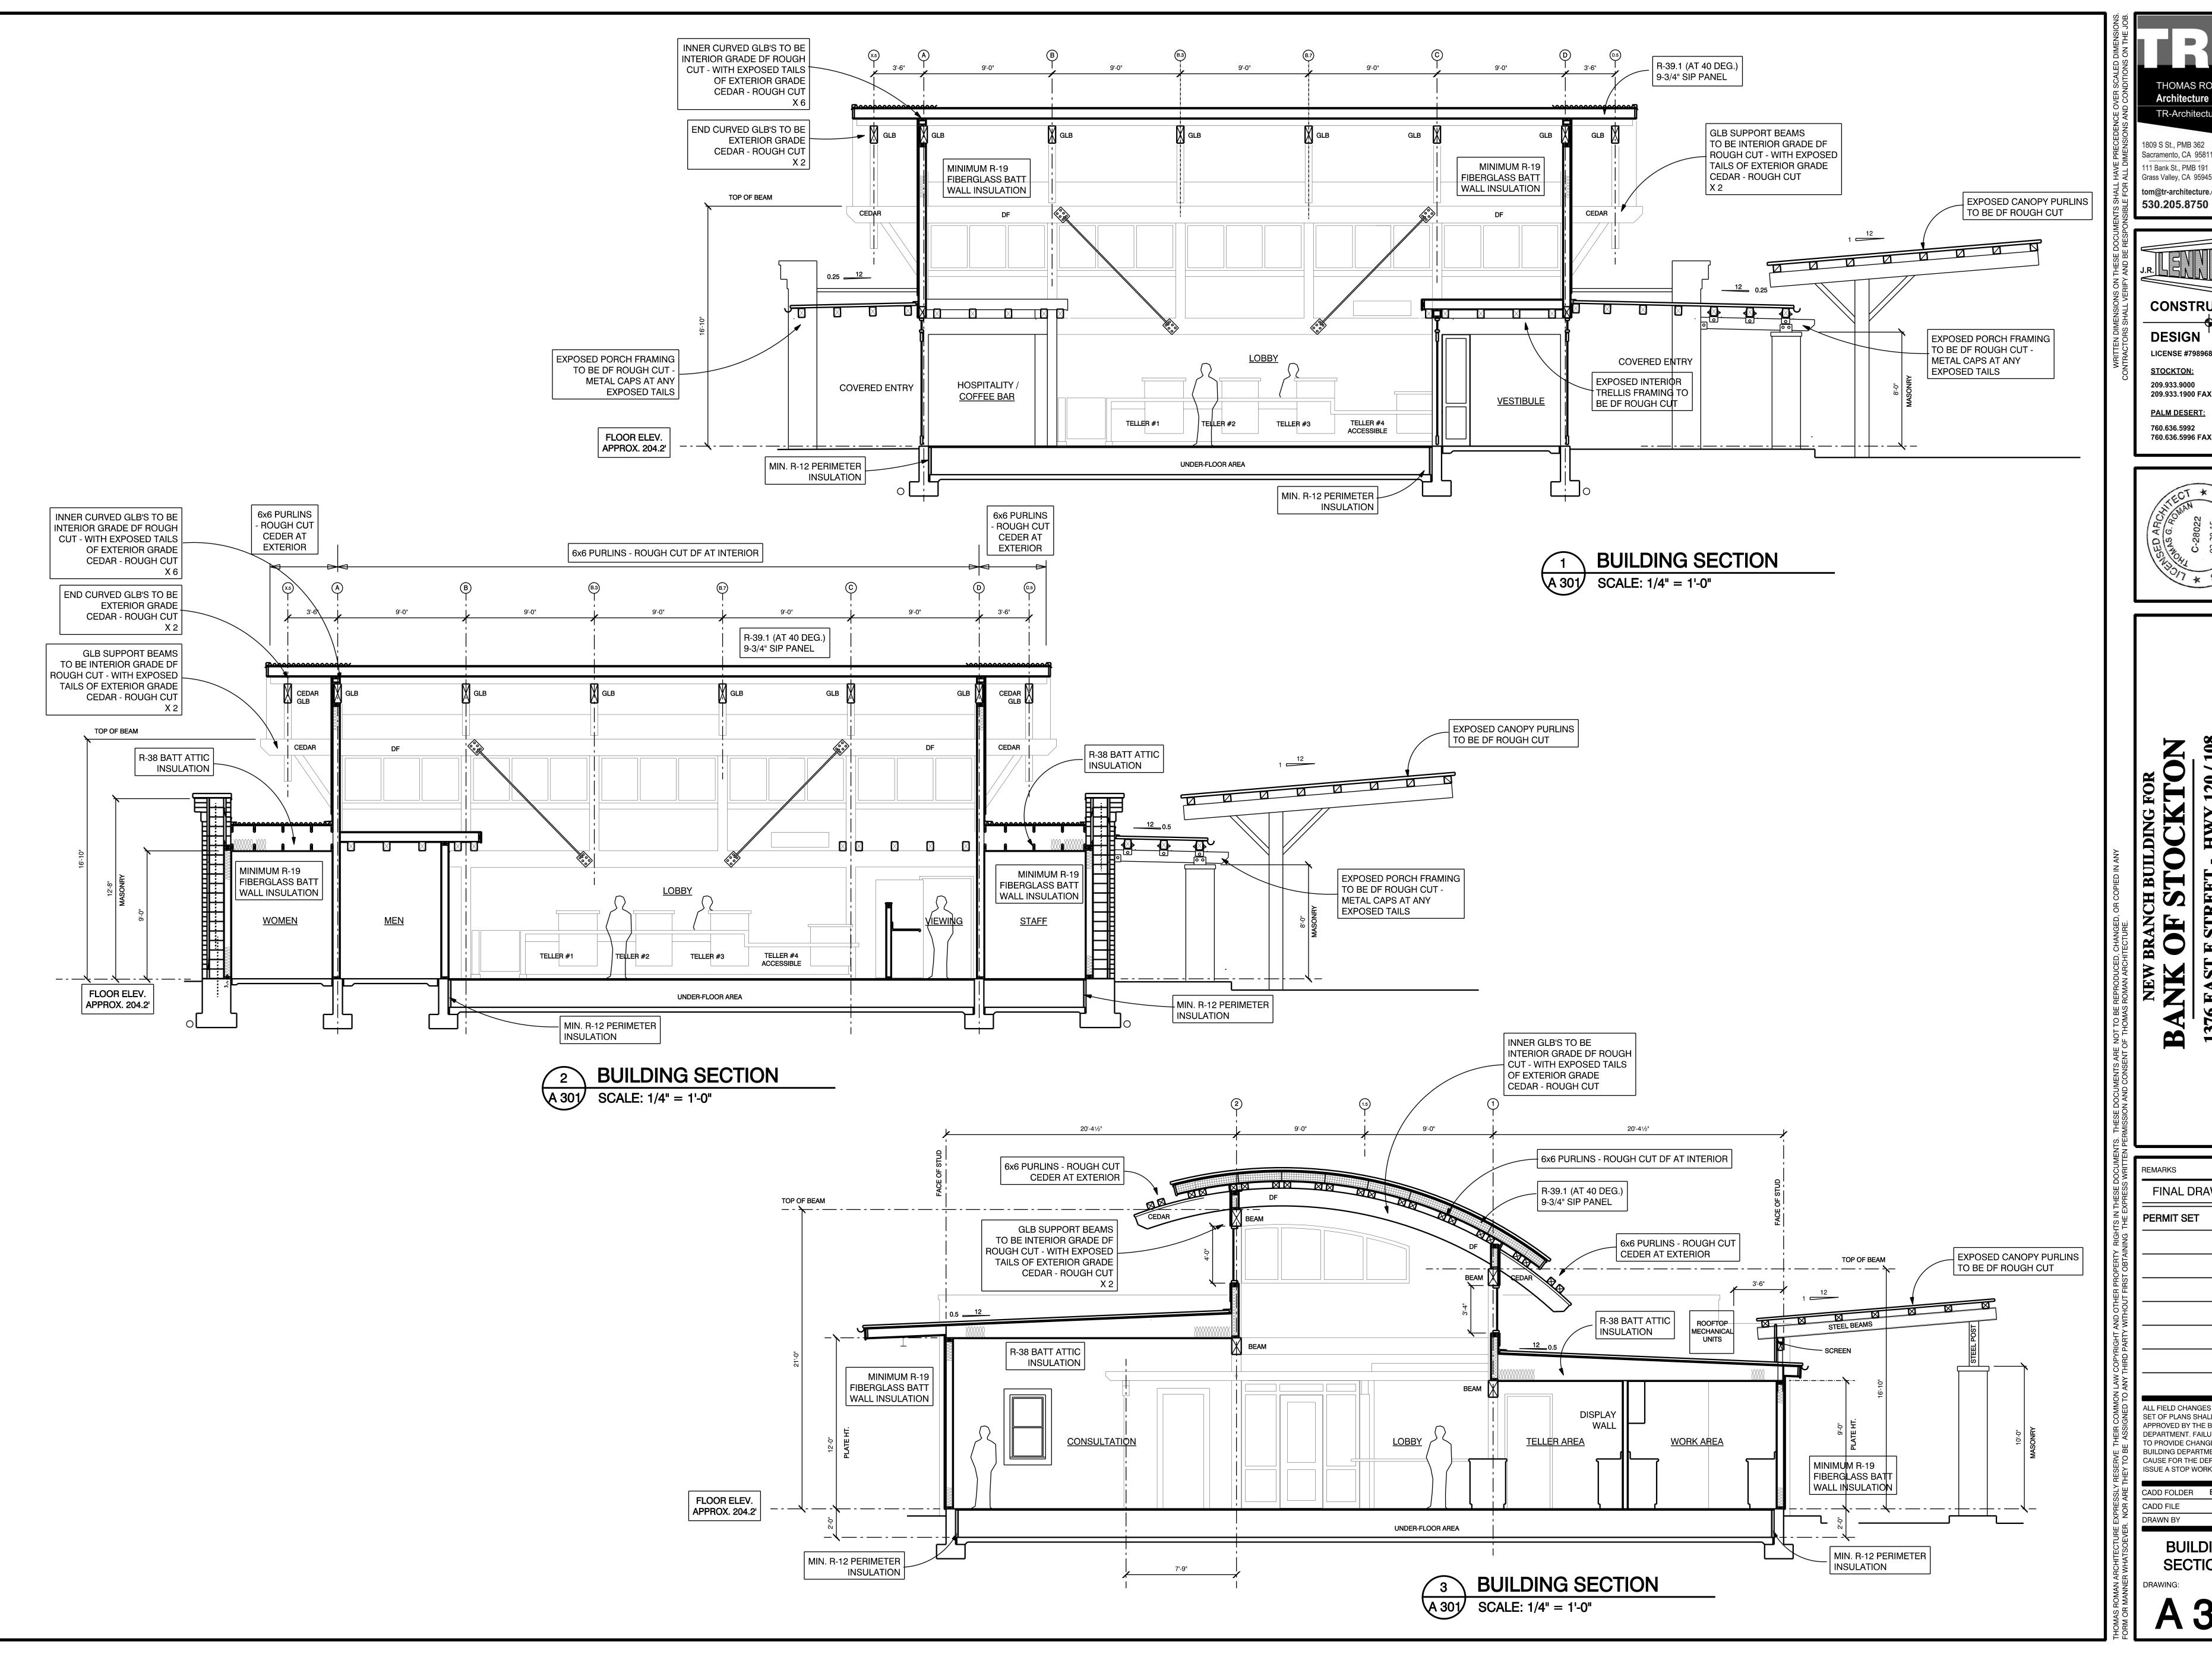
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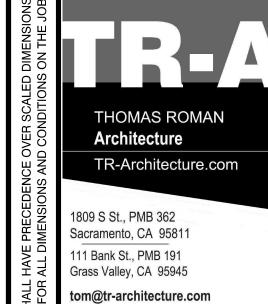
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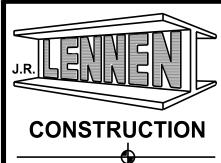
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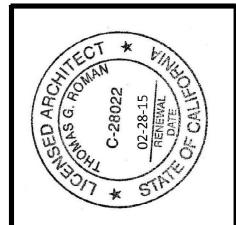




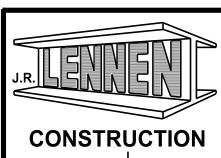

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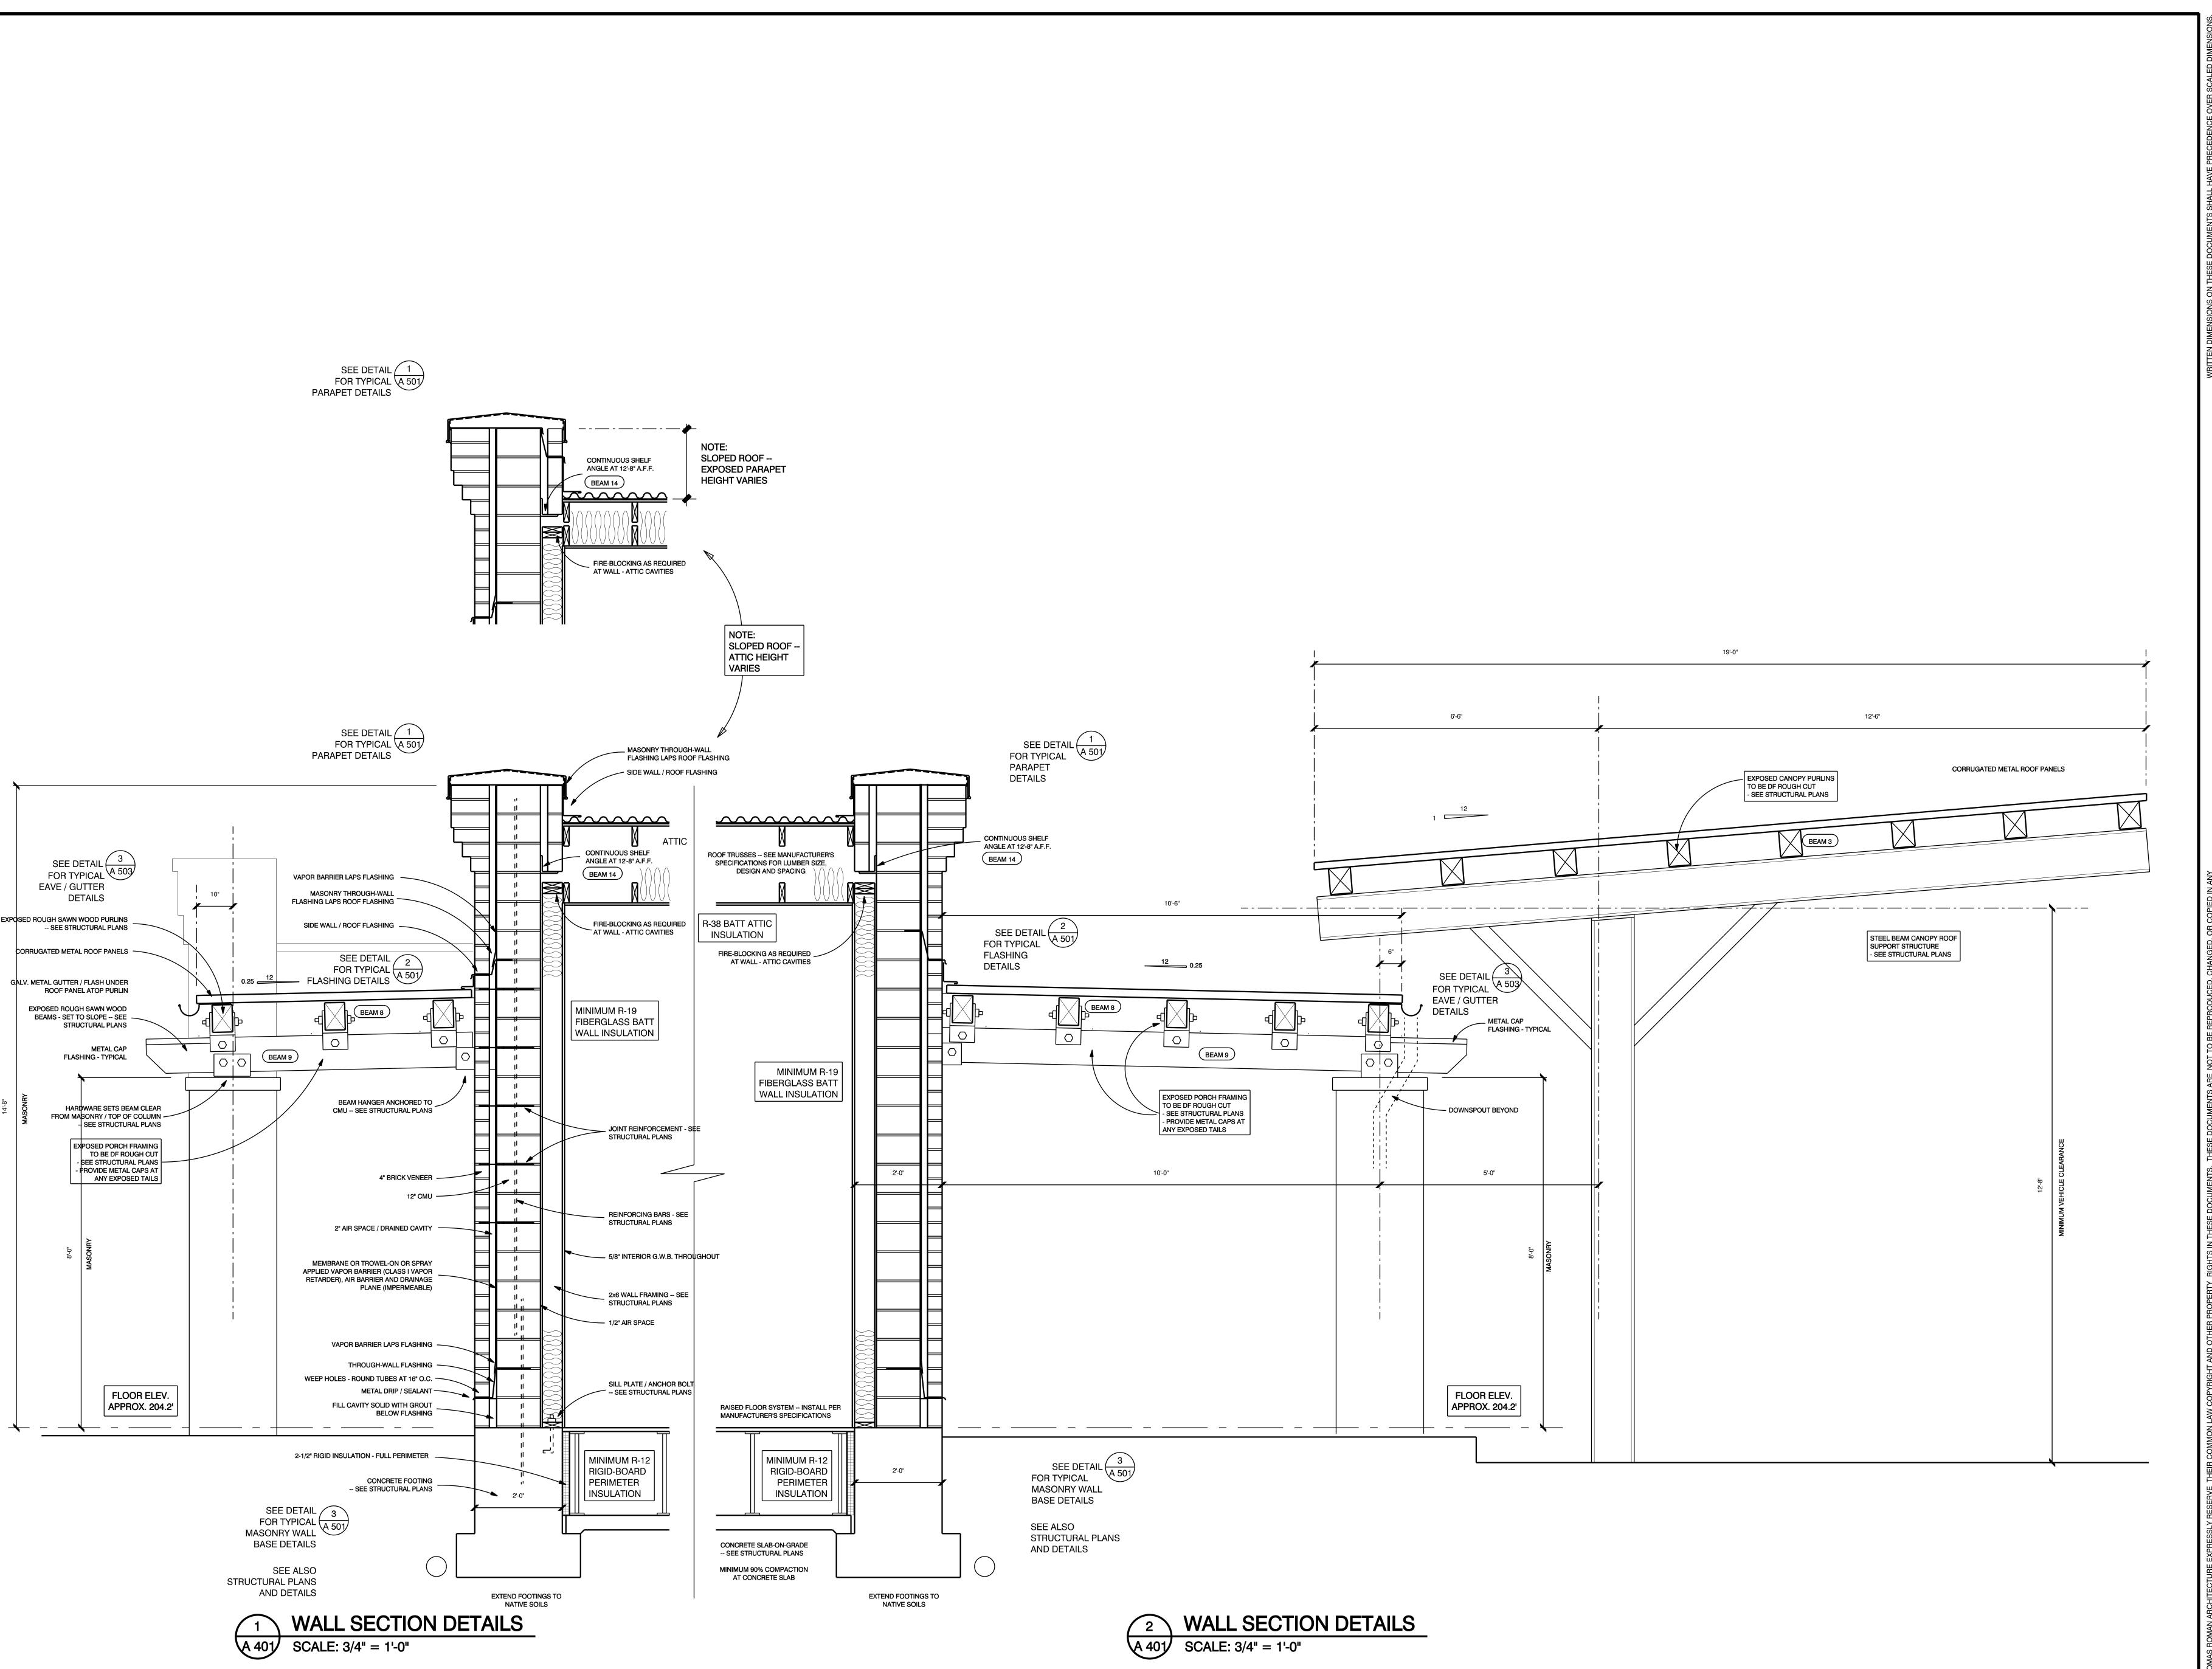
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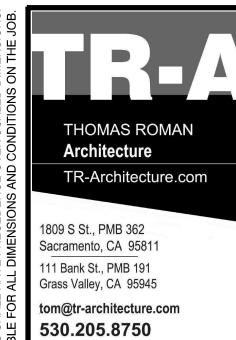
TO PROVIDE CHANGES TO THE BUILDING DEPARTMENT WILL BE CAUSE FOR THE DEPARTMENT TO ISSUE A STOP WORK NOTICE.


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> **BUILDING SECTIONS**

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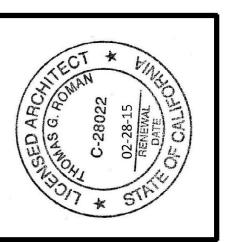






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OAKDALE, CA.

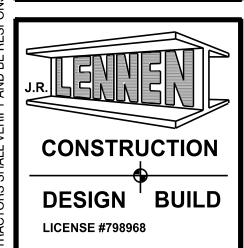
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CADD FOLDER
BOS OAKDALE

CADD FOLDER BOS OAKDALE
CADD FILE SECTIONS
DRAWN BY TR

WALL SECTION DETAILS



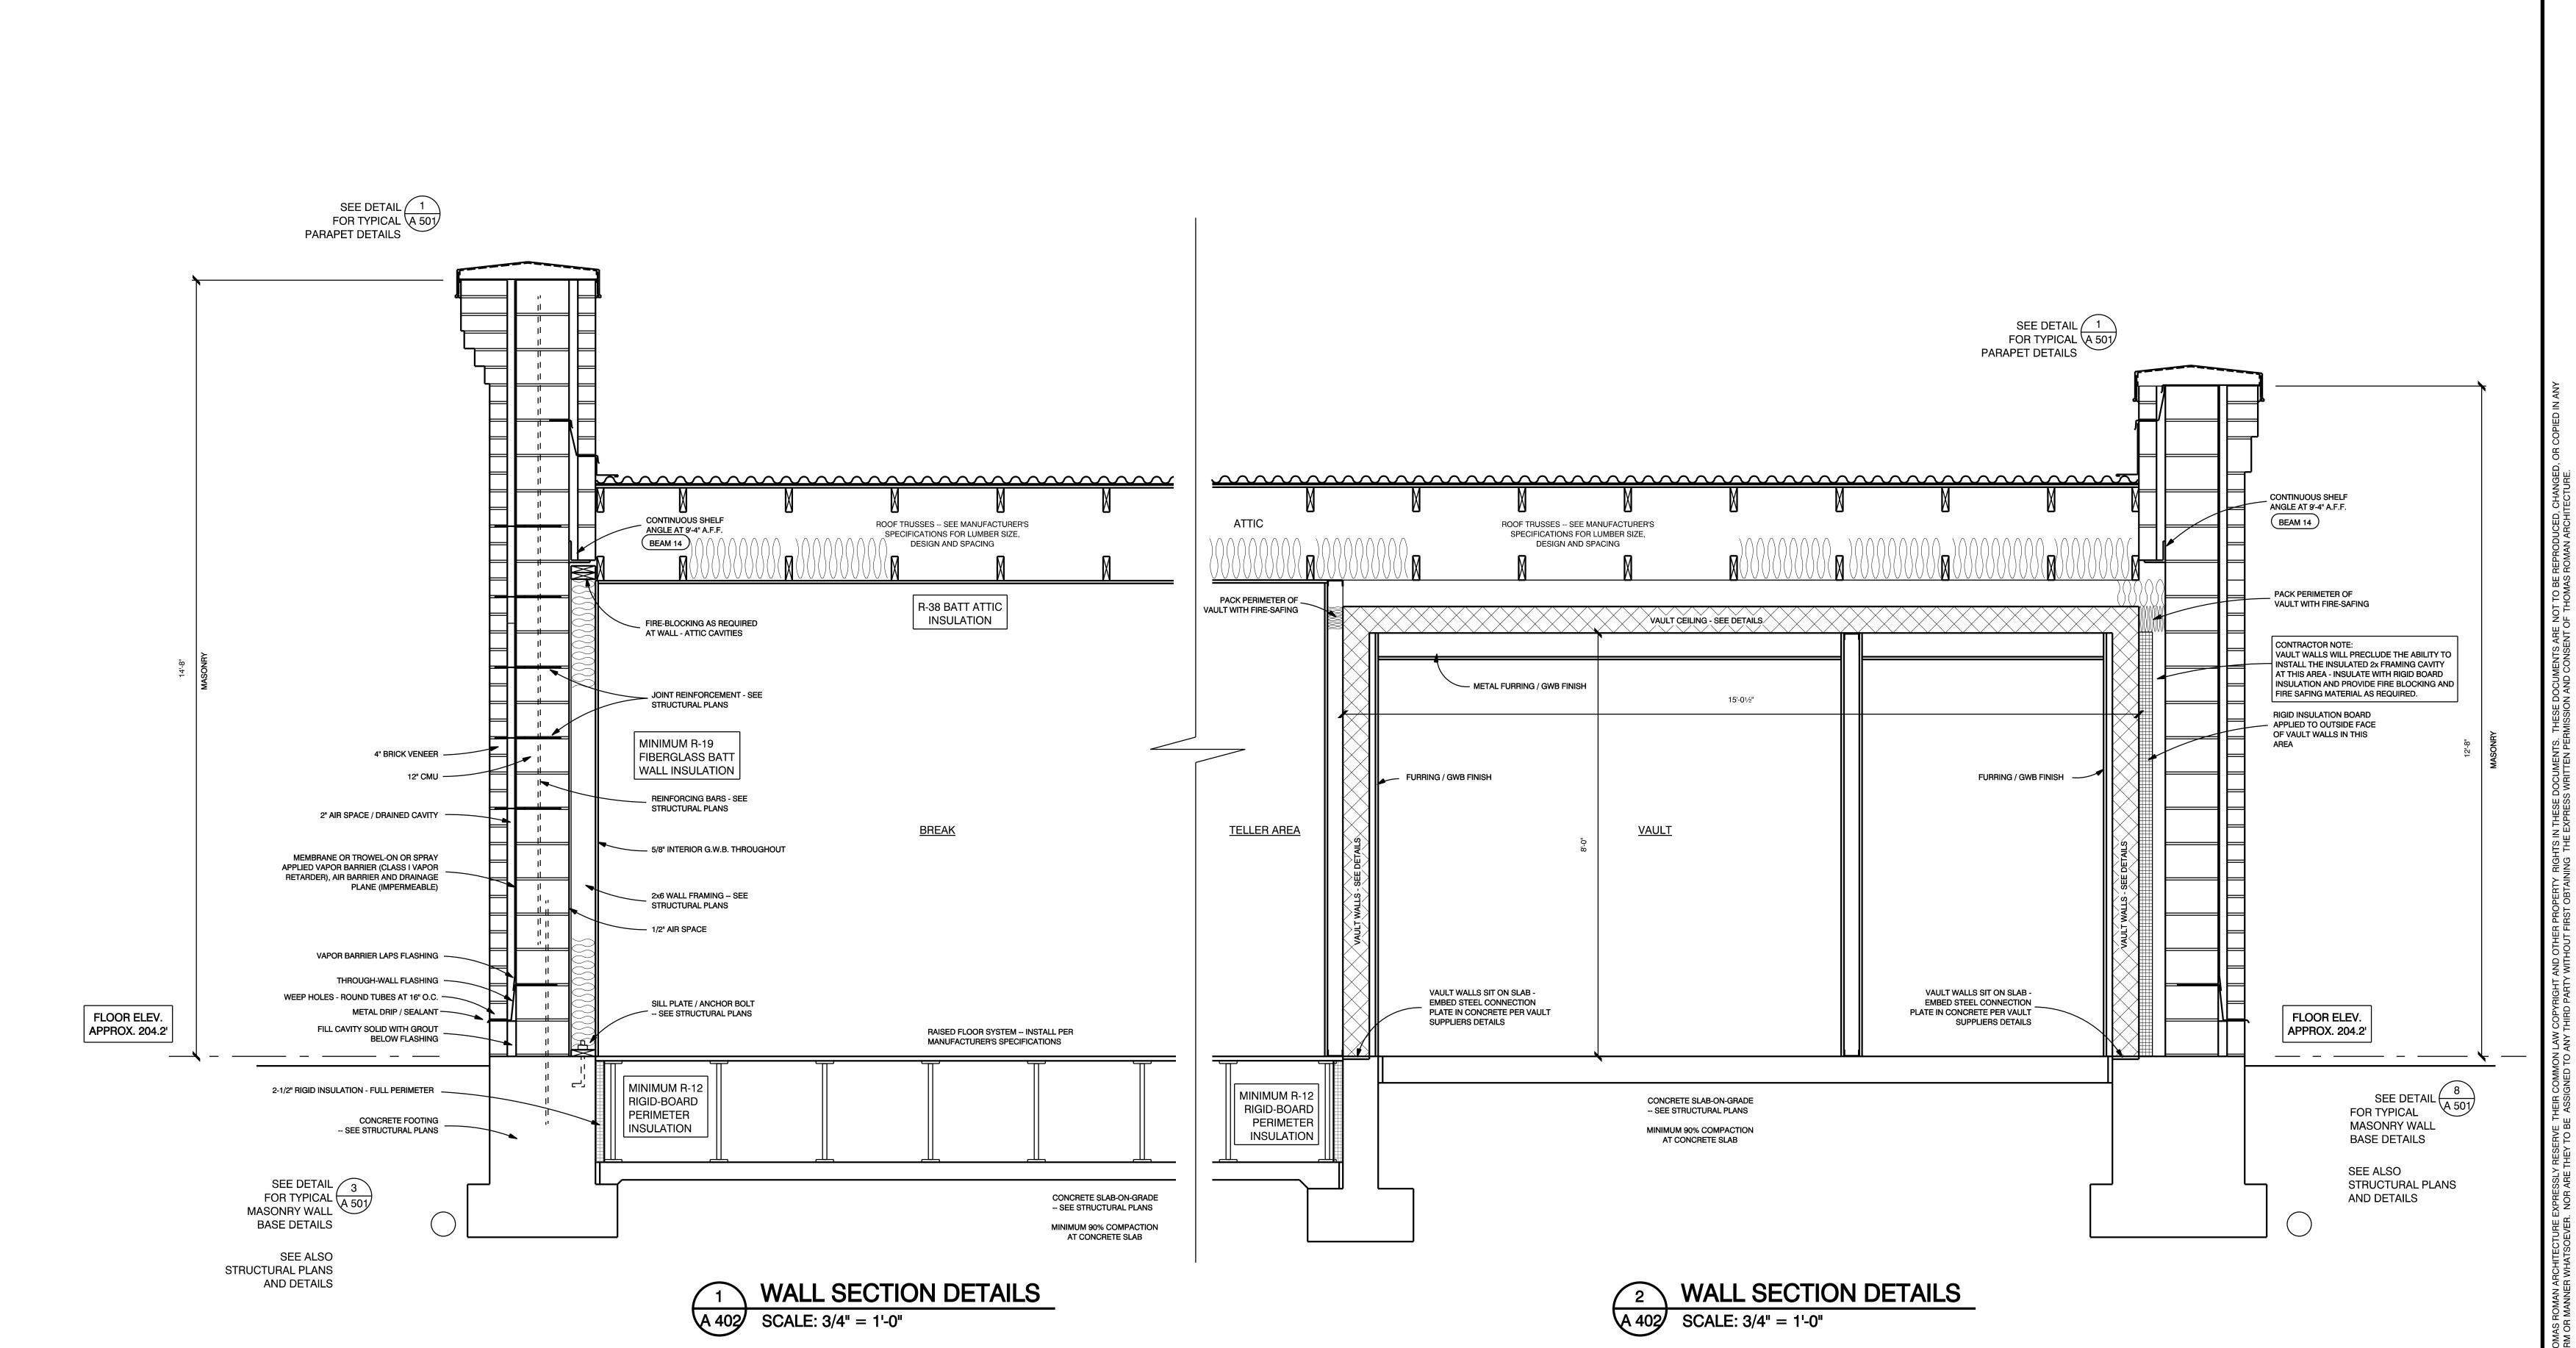


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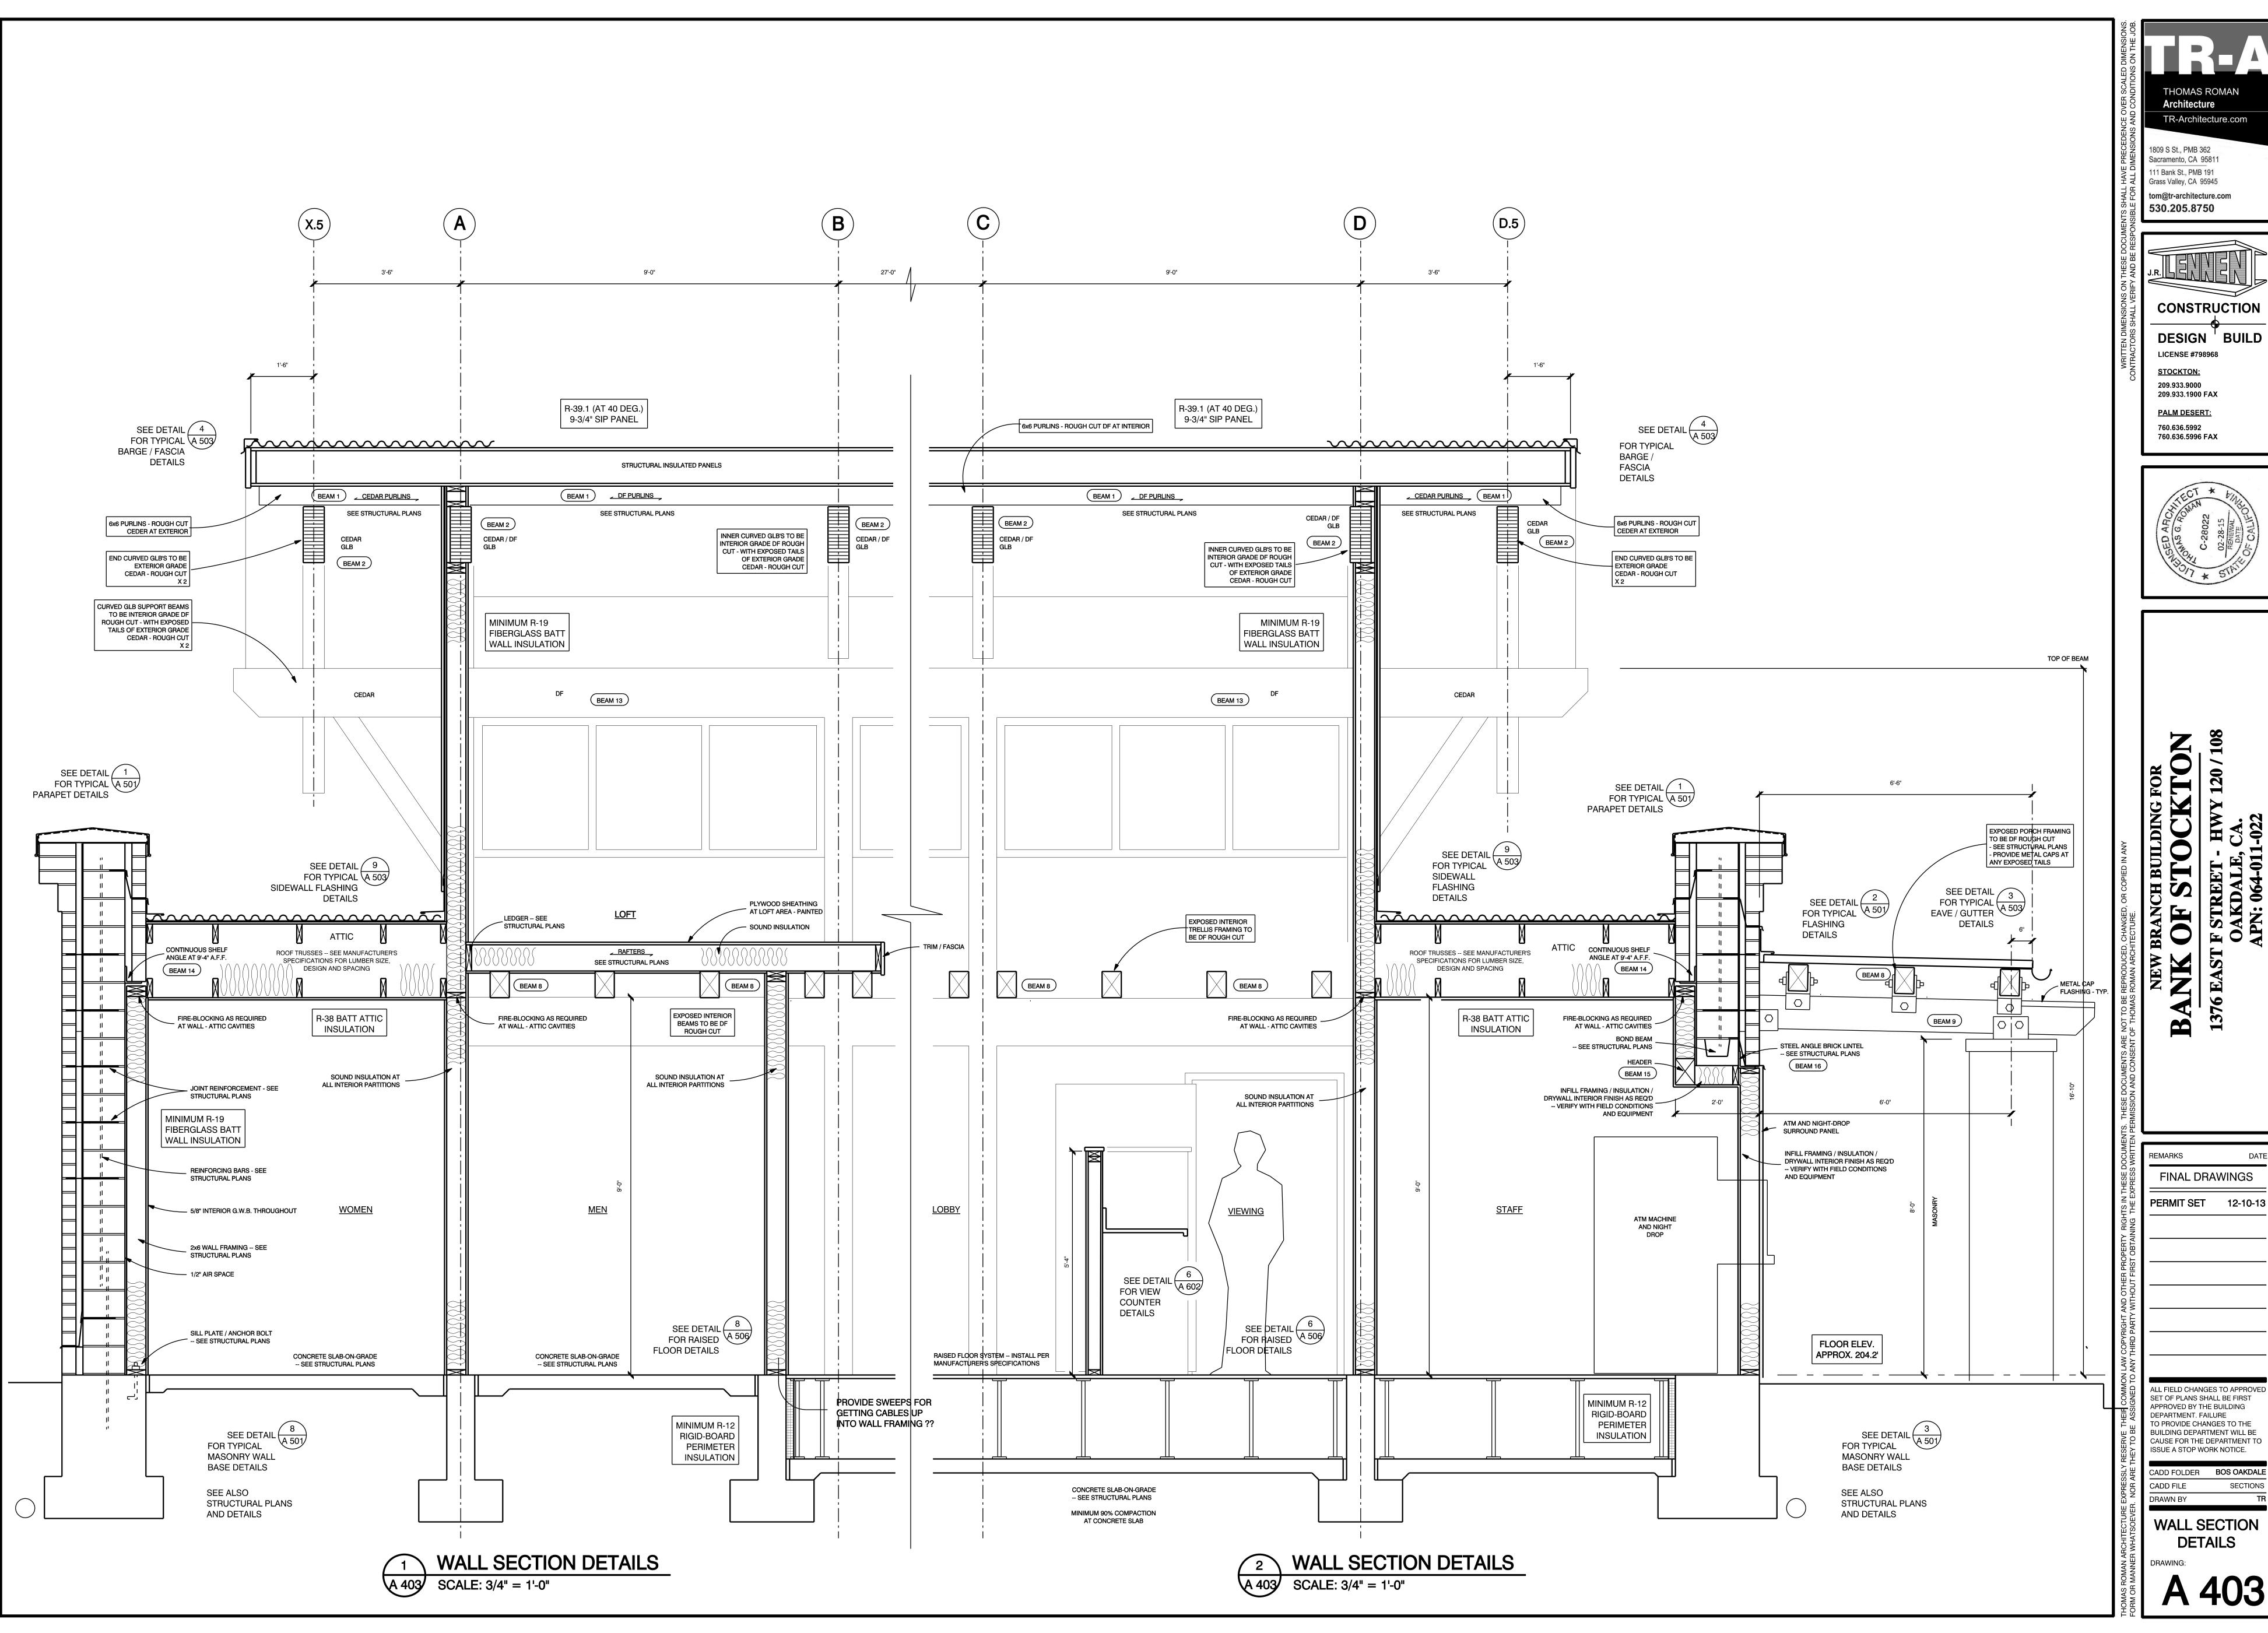
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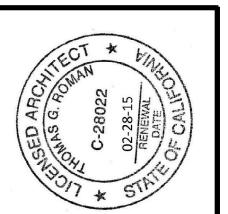
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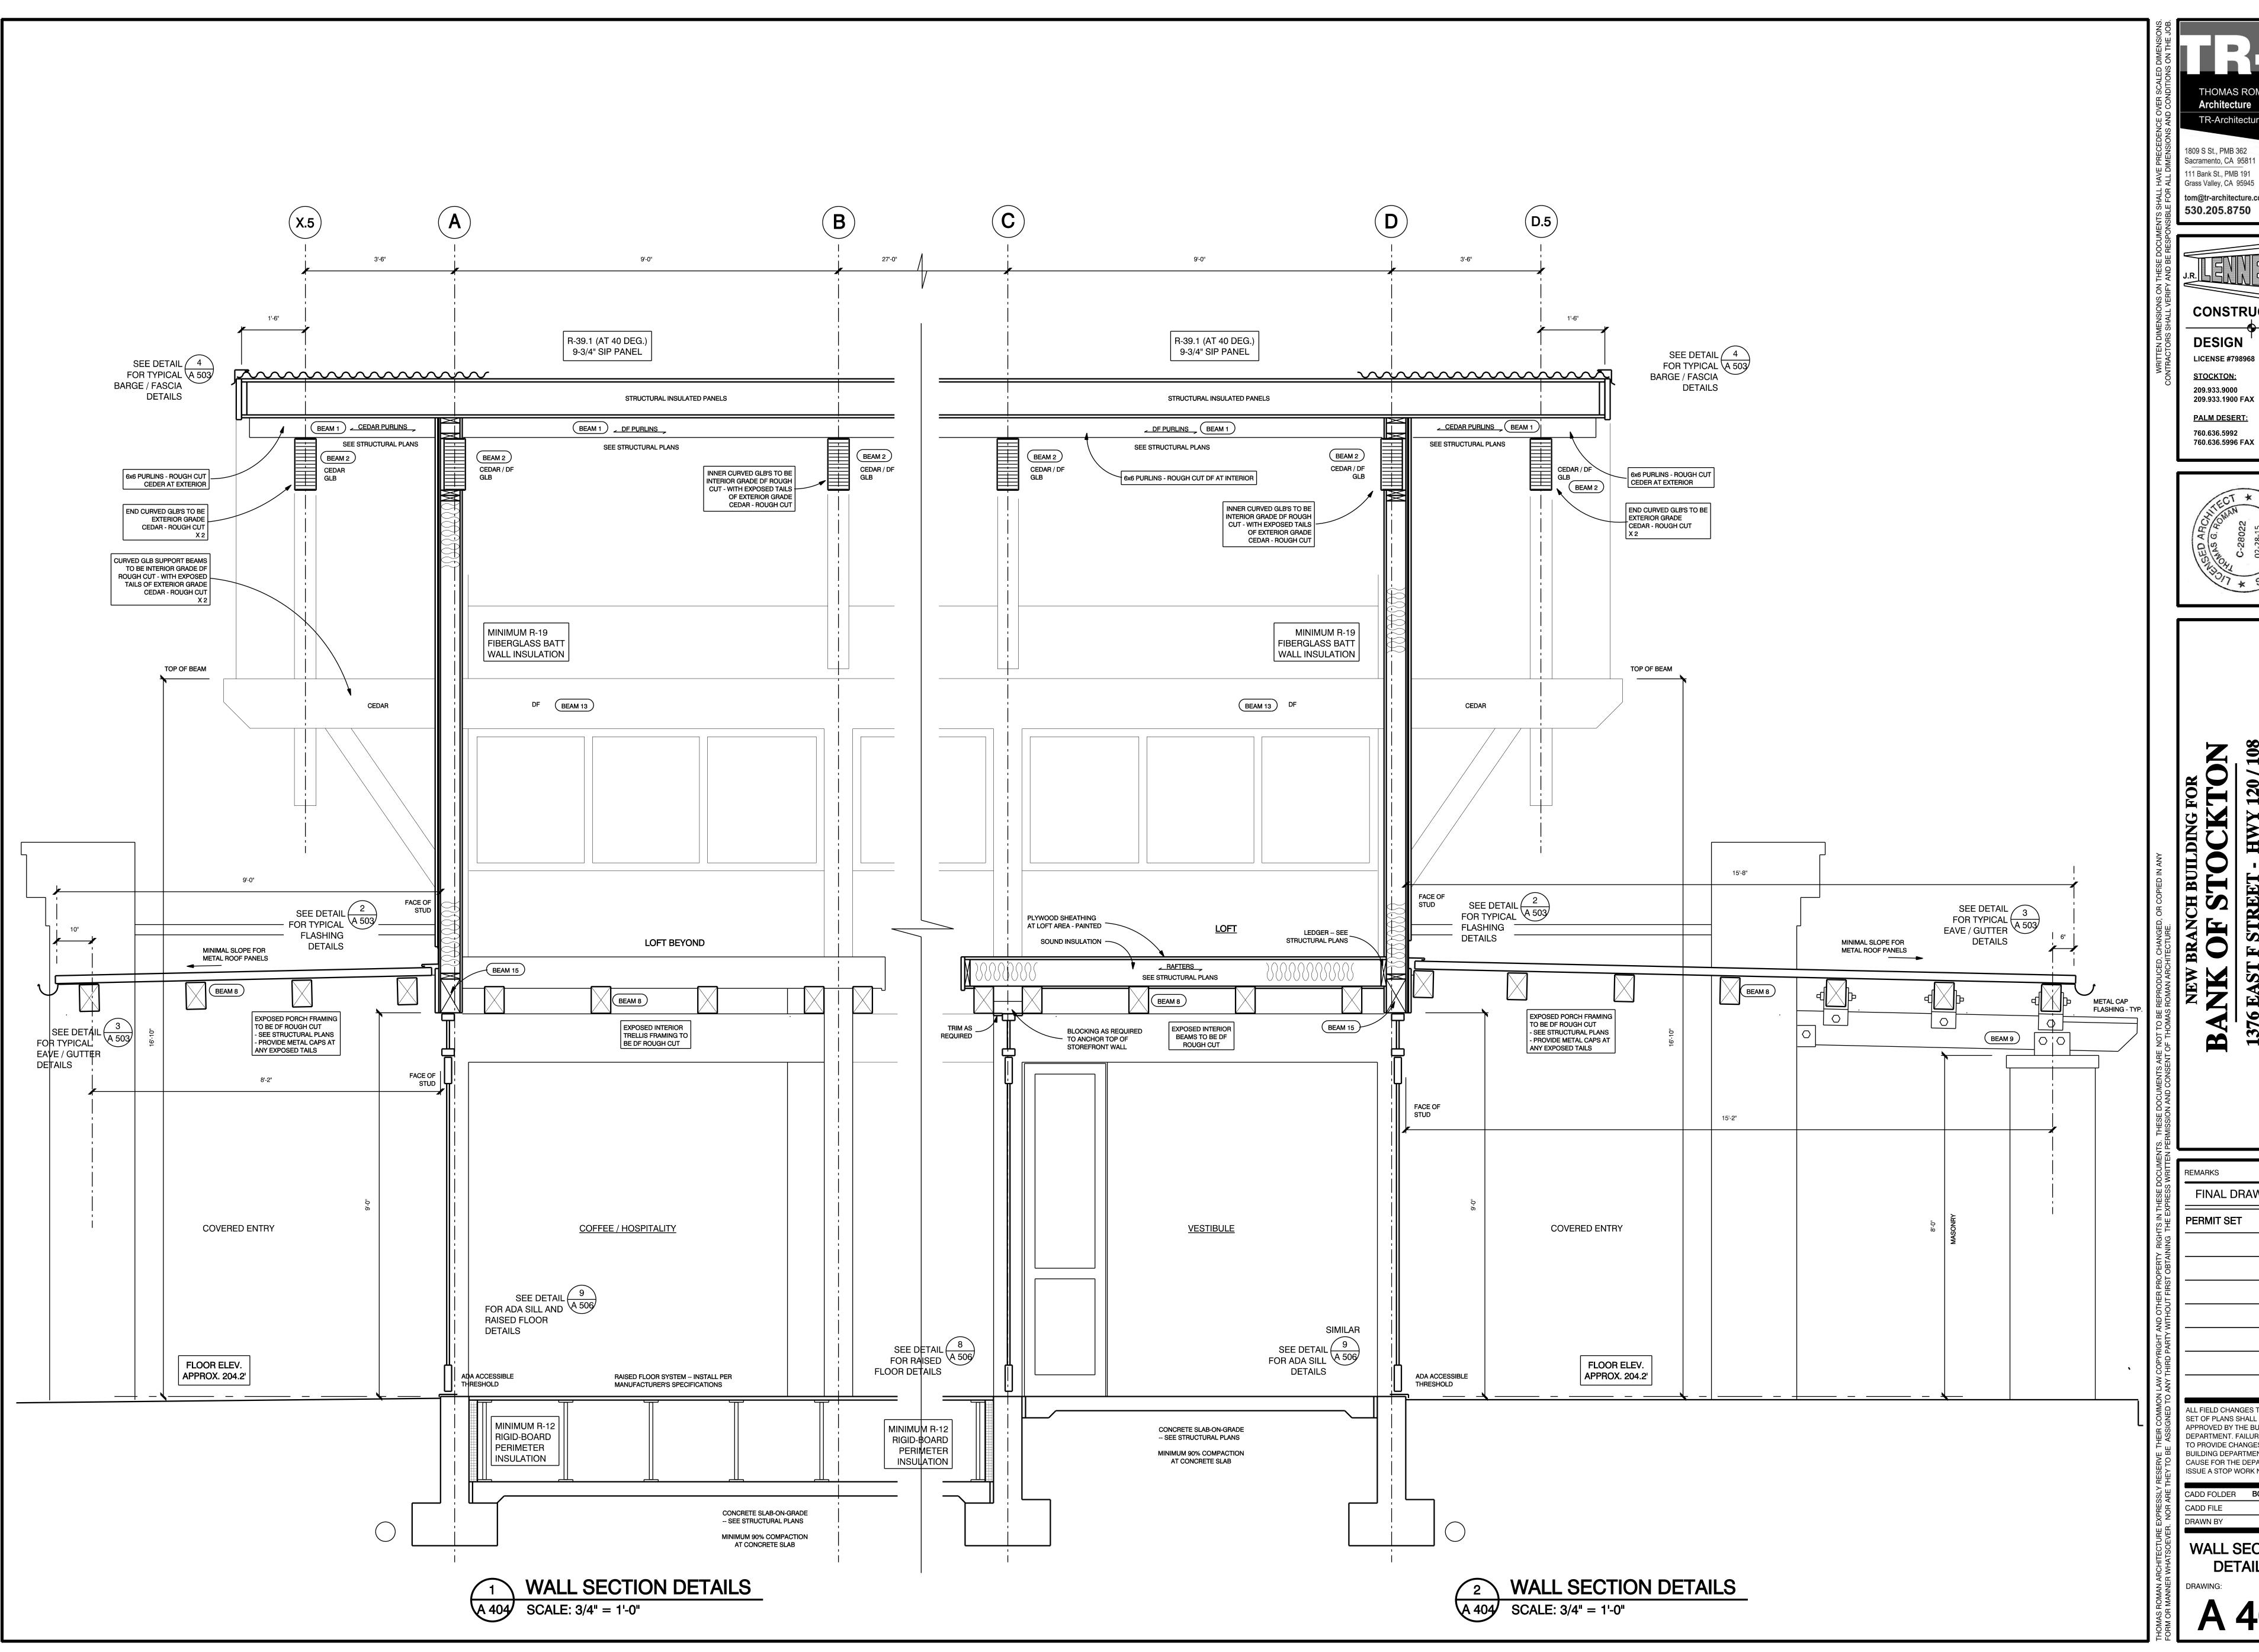
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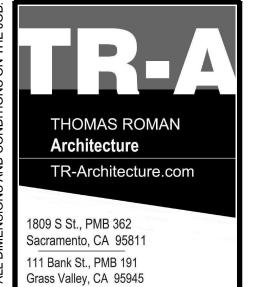
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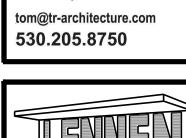




ALL FIELD CHANGES TO APPROVED SET OF PLANS SHALL BE FIRST






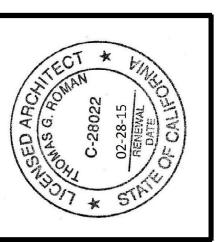


CONSTRUCTION

DESIGN BUILD **LICENSE #798968**

STOCKTON: 209.933.9000 209.933.1900 FAX PALM DESERT: 760.636.5992

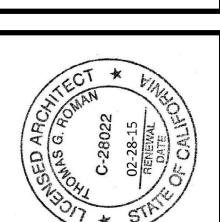

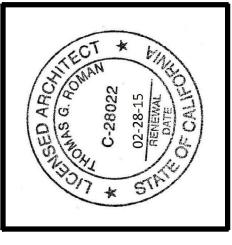


NEW BRANCH BUILDING FOR BANK OF STOCKTON

FINAL DRAWINGS PERMIT SET


ALL FIELD CHANGES TO APPROVED SET OF PLANS SHALL BE FIRST APPROVED BY THE BUILDING DEPARTMENT. FAILURE TO PROVIDE CHANGES TO THE BUILDING DEPARTMENT WILL BE CAUSE FOR THE DEPARTMENT TO ISSUE A STOP WORK NOTICE.

CADD FOLDER BOS OAKDALE DRAWN BY

WALL SECTION **DETAILS**

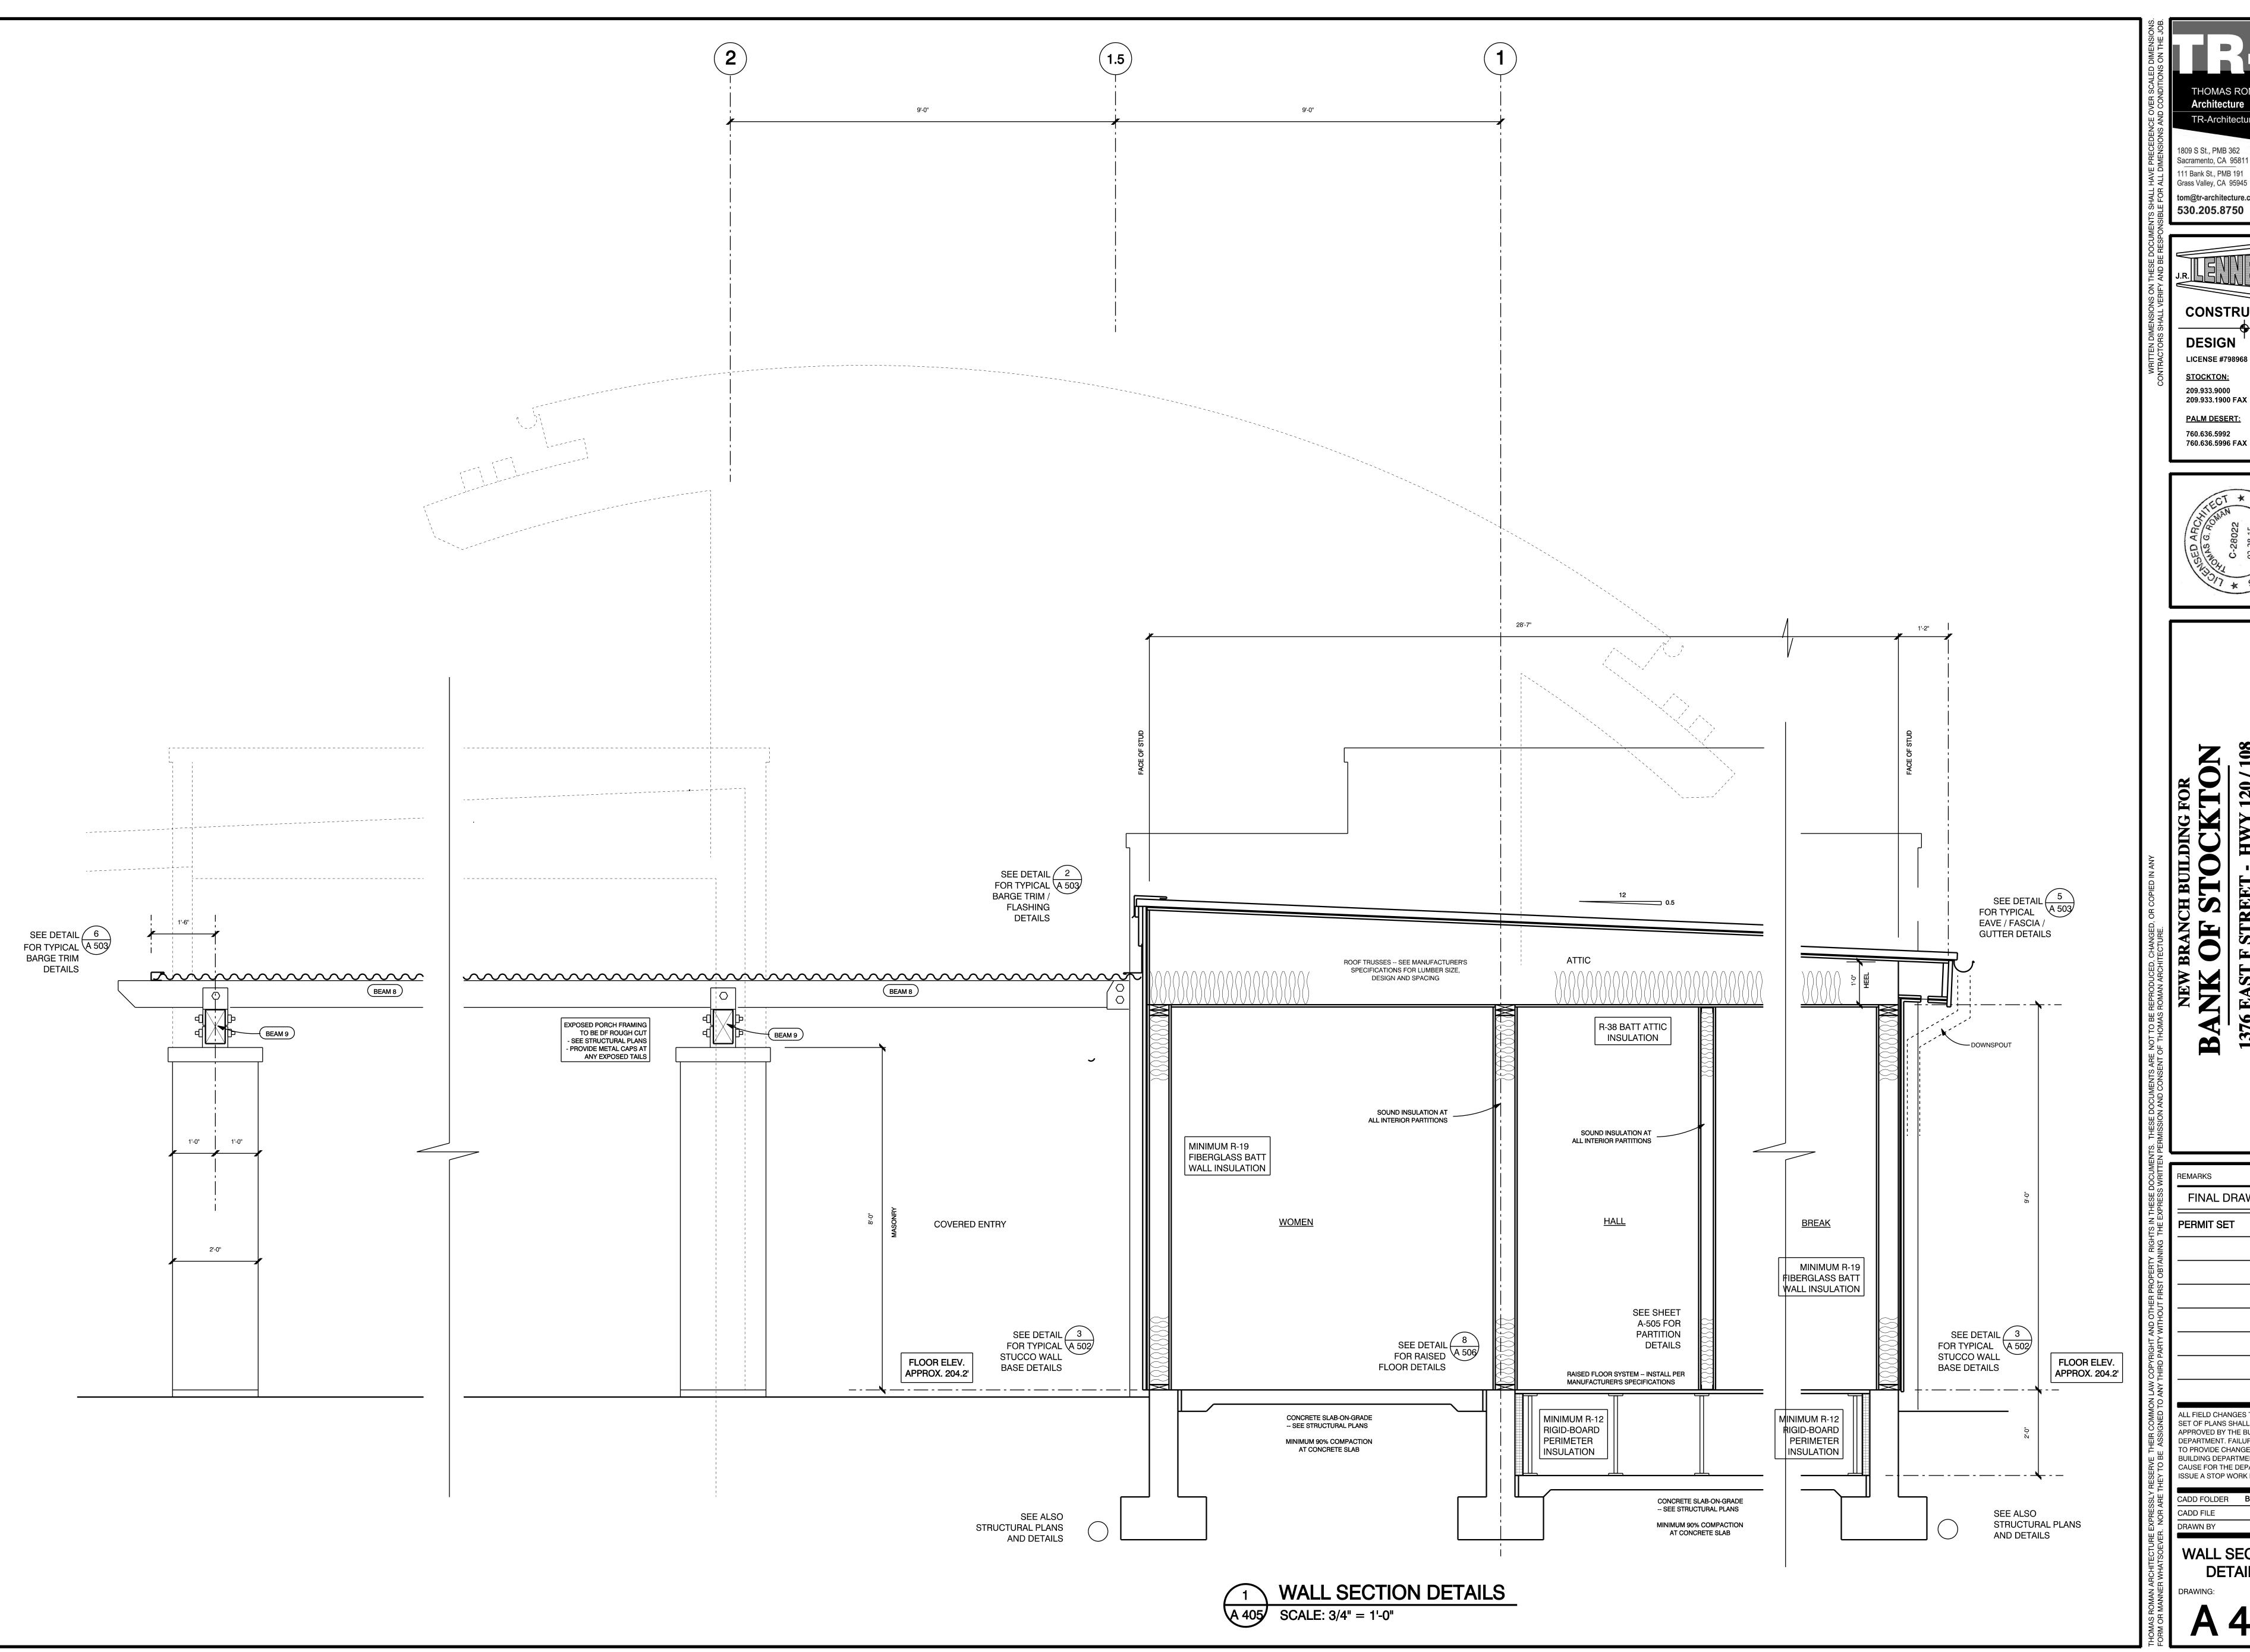

Architecture TR-Architecture.com 1809 S St., PMB 362 Sacramento, CA 95811 111 Bank St., PMB 191

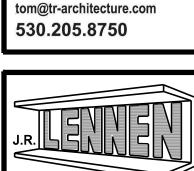


CONSTRUCTION

DESIGN BUILD **LICENSE #798968**

STOCKTON: 209.933.9000 209.933.1900 FAX


PALM DESERT: 760.636.5992 760.636.5996 FAX

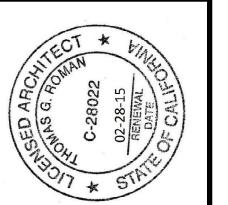

FINAL DRAWINGS PERMIT SET 12-10-13 ALL FIELD CHANGES TO APPROVED SET OF PLANS SHALL BE FIRST APPROVED BY THE BUILDING DEPARTMENT. FAILURE


TO PROVIDE CHANGES TO THE BUILDING DEPARTMENT WILL BE CAUSE FOR THE DEPARTMENT TO ISSUE A STOP WORK NOTICE. CADD FOLDER BOS OAKDALE

DRAWN BY WALL SECTION **DETAILS**

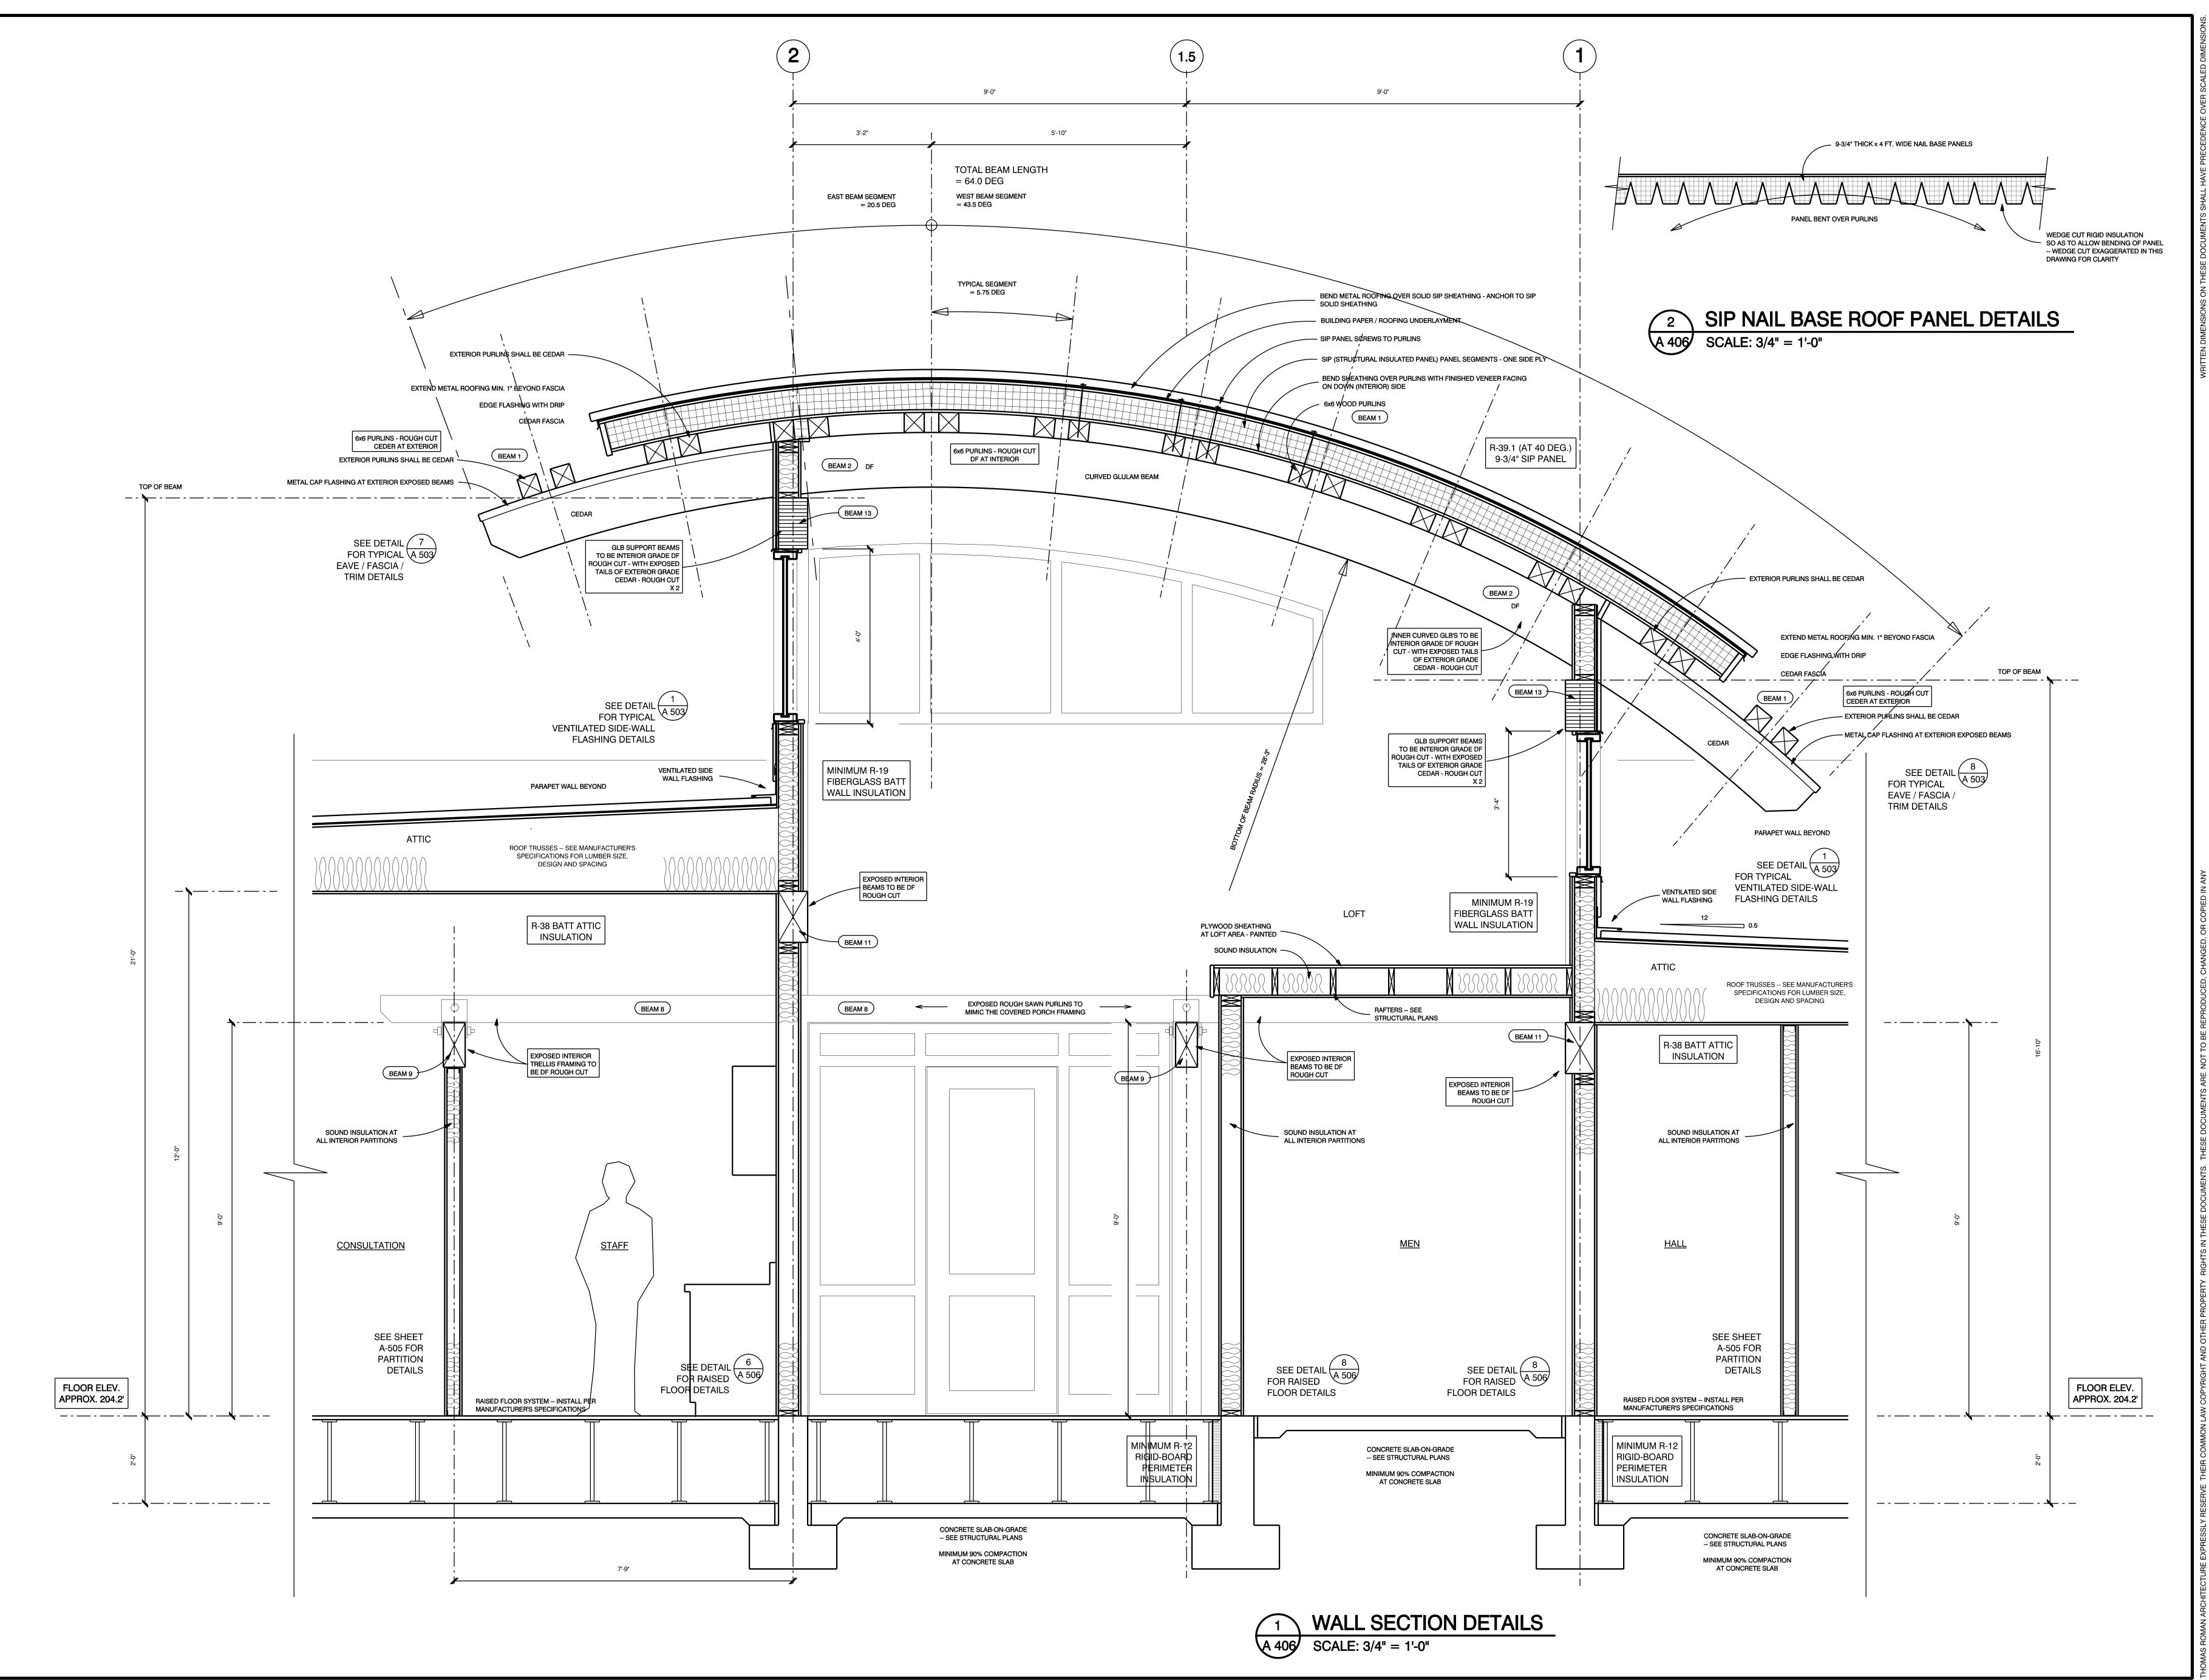




530.205.8750

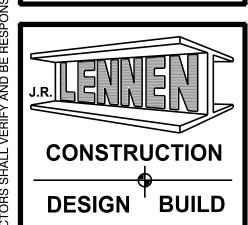

DESIGN BUIL
LICENSE #798968

STOCKTON:
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209.933.1900 FAX

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BANK OF STOCKTON

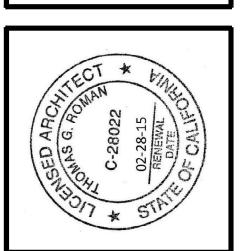
1376 EAST F STREET - HWY 120 / 108
OAKDALE, CA.

REMARKS	DATE		
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PERMIT SET	12-10-13		
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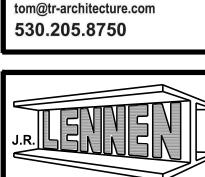
ALL FIELD CHANGES TO APPROVED SET OF PLANS SHALL BE FIRST APPROVED BY THE BUILDING DEPARTMENT. FAILURE TO PROVIDE CHANGES TO THE BUILDING DEPARTMENT WILL BE CAUSE FOR THE DEPARTMENT TO ISSUE A STOP WORK NOTICE.

CADD FOLDER BOS OAKDALE
CADD FILE SECTIONS
DRAWN BY TR

WALL SECTION DETAILS




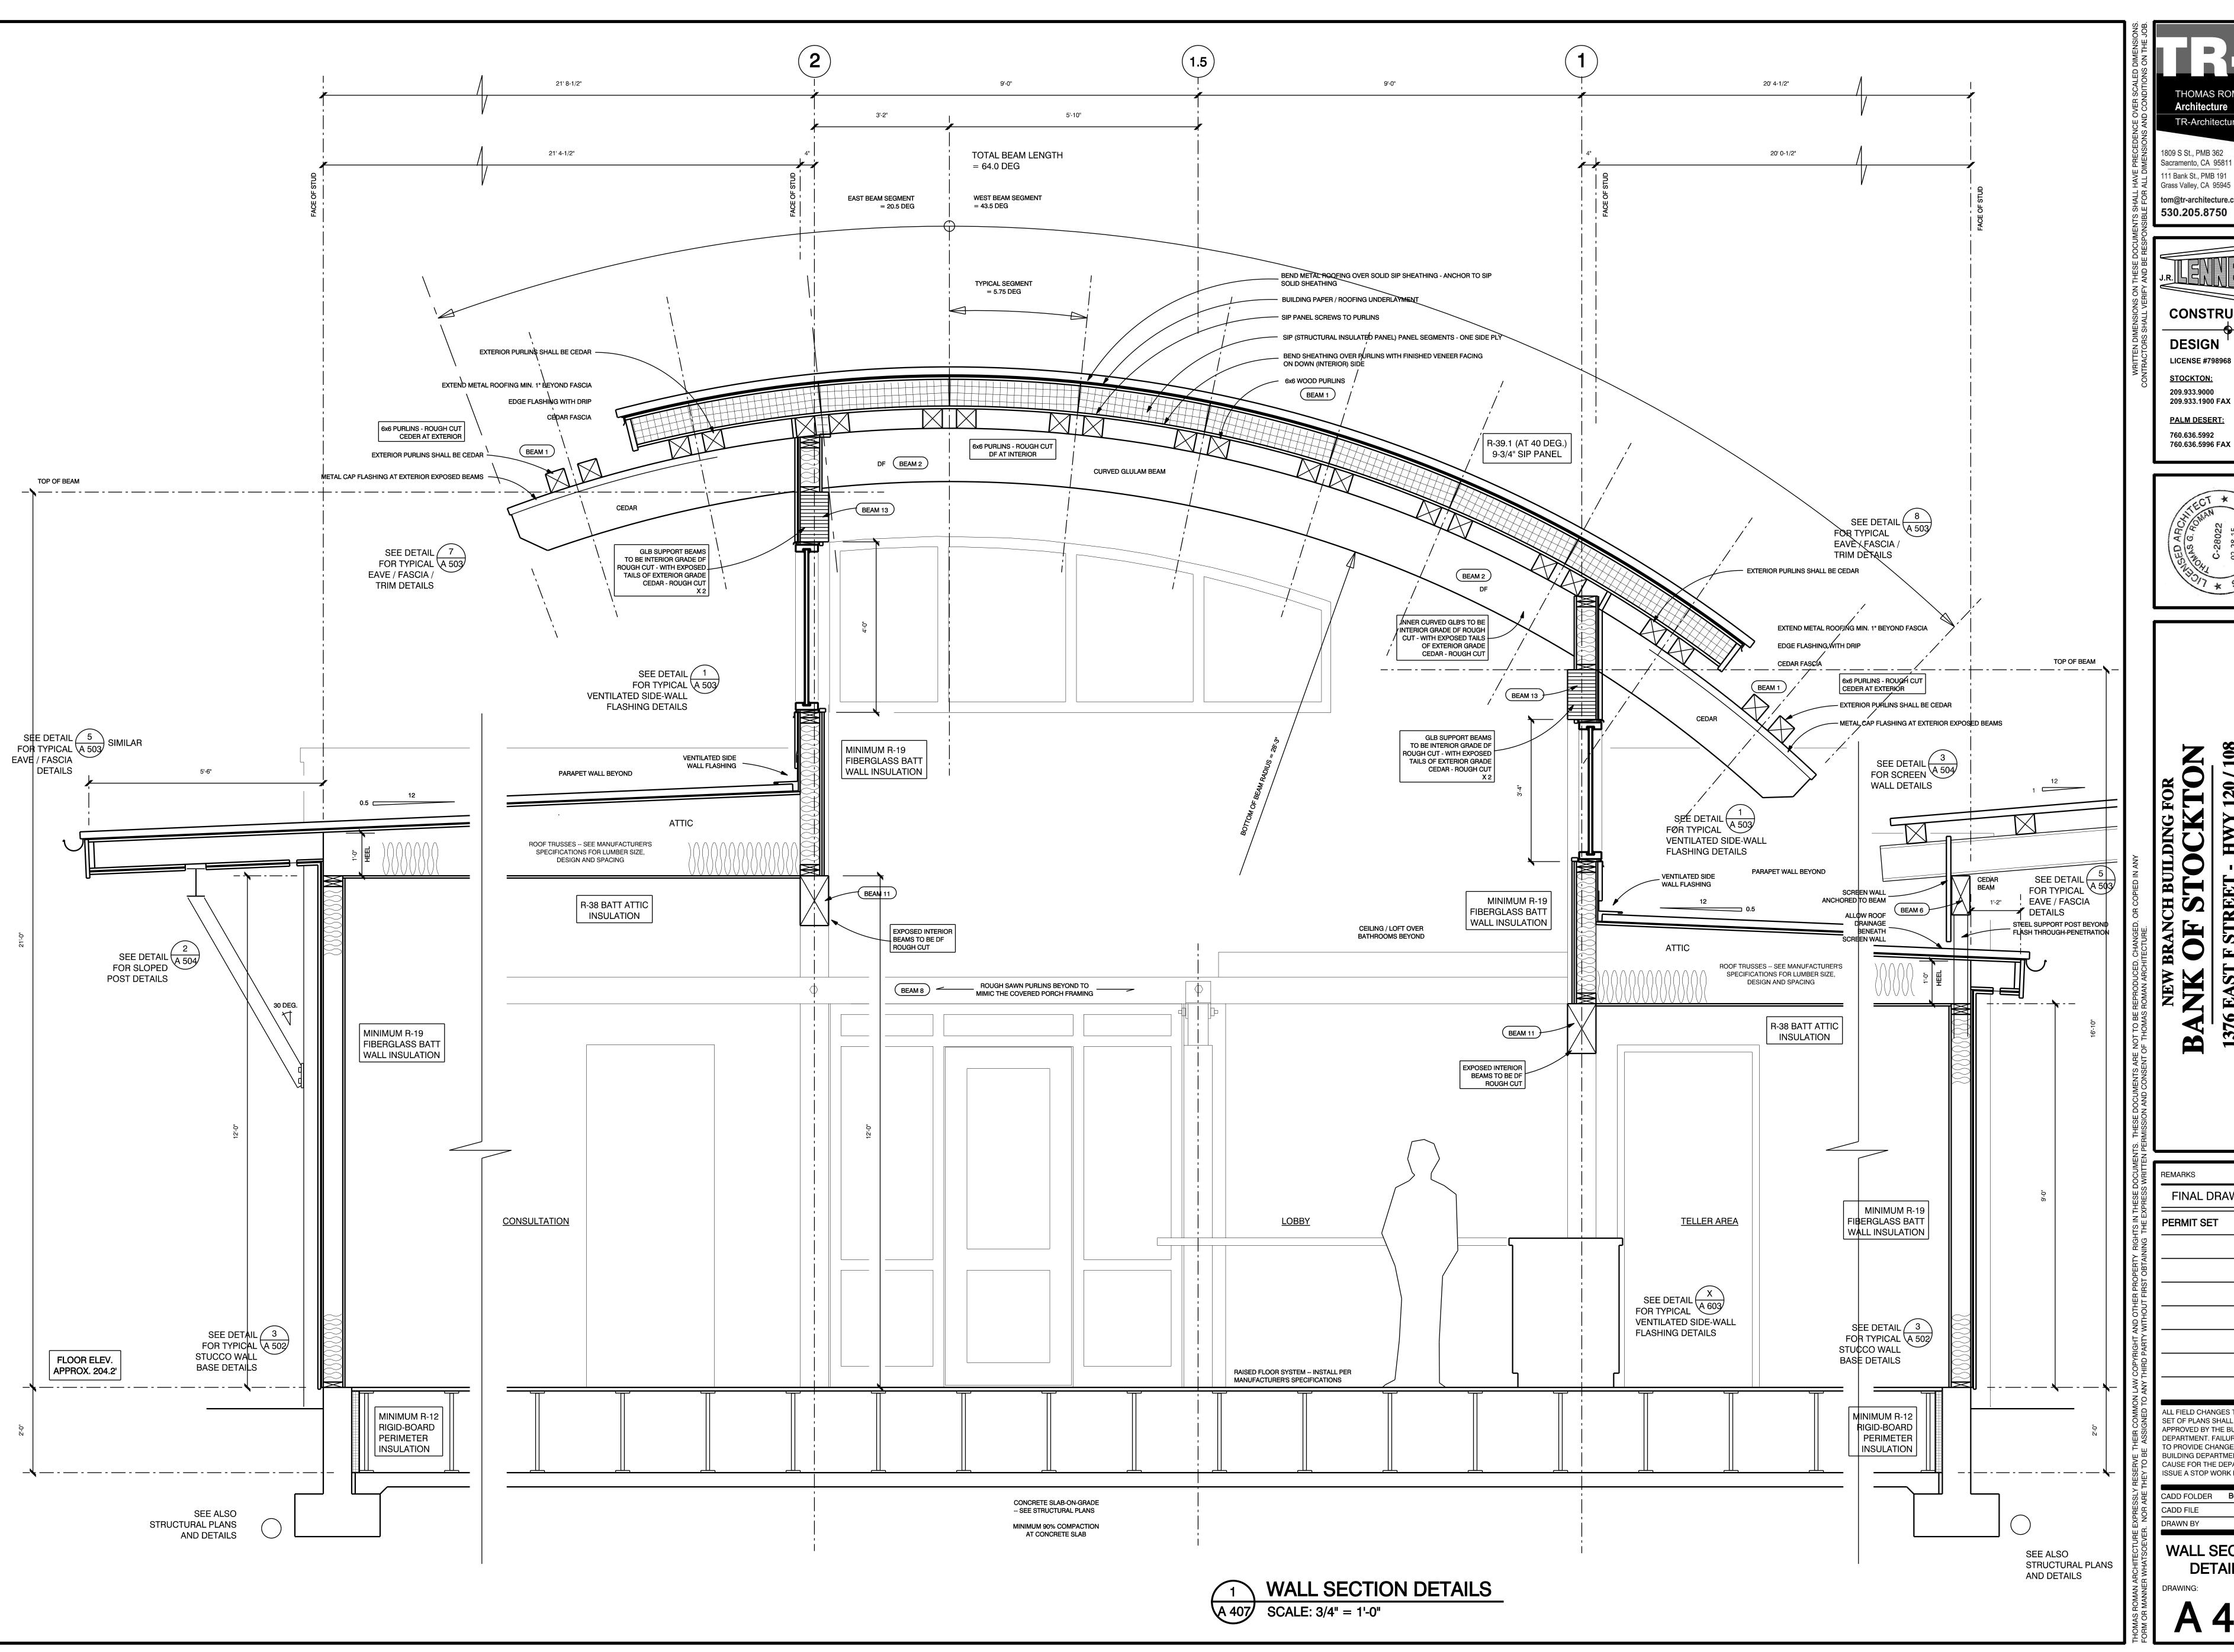



CONSTRUCTION

LICENSE #798968 STOCKTON: 209.933.9000 209.933.1900 FAX PALM DESERT: 760.636.5992

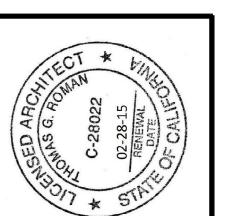


FINAL DRAWINGS PERMIT SET ALL FIELD CHANGES TO APPROVED SET OF PLANS SHALL BE FIRST APPROVED BY THE BUILDING DEPARTMENT. FAILURE


TO PROVIDE CHANGES TO THE BUILDING DEPARTMENT WILL BE CAUSE FOR THE DEPARTMENT TO ISSUE A STOP WORK NOTICE.


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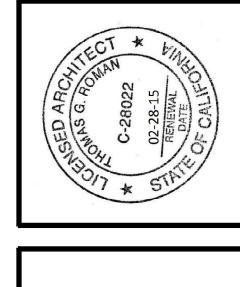
WALL SECTION **DETAILS**

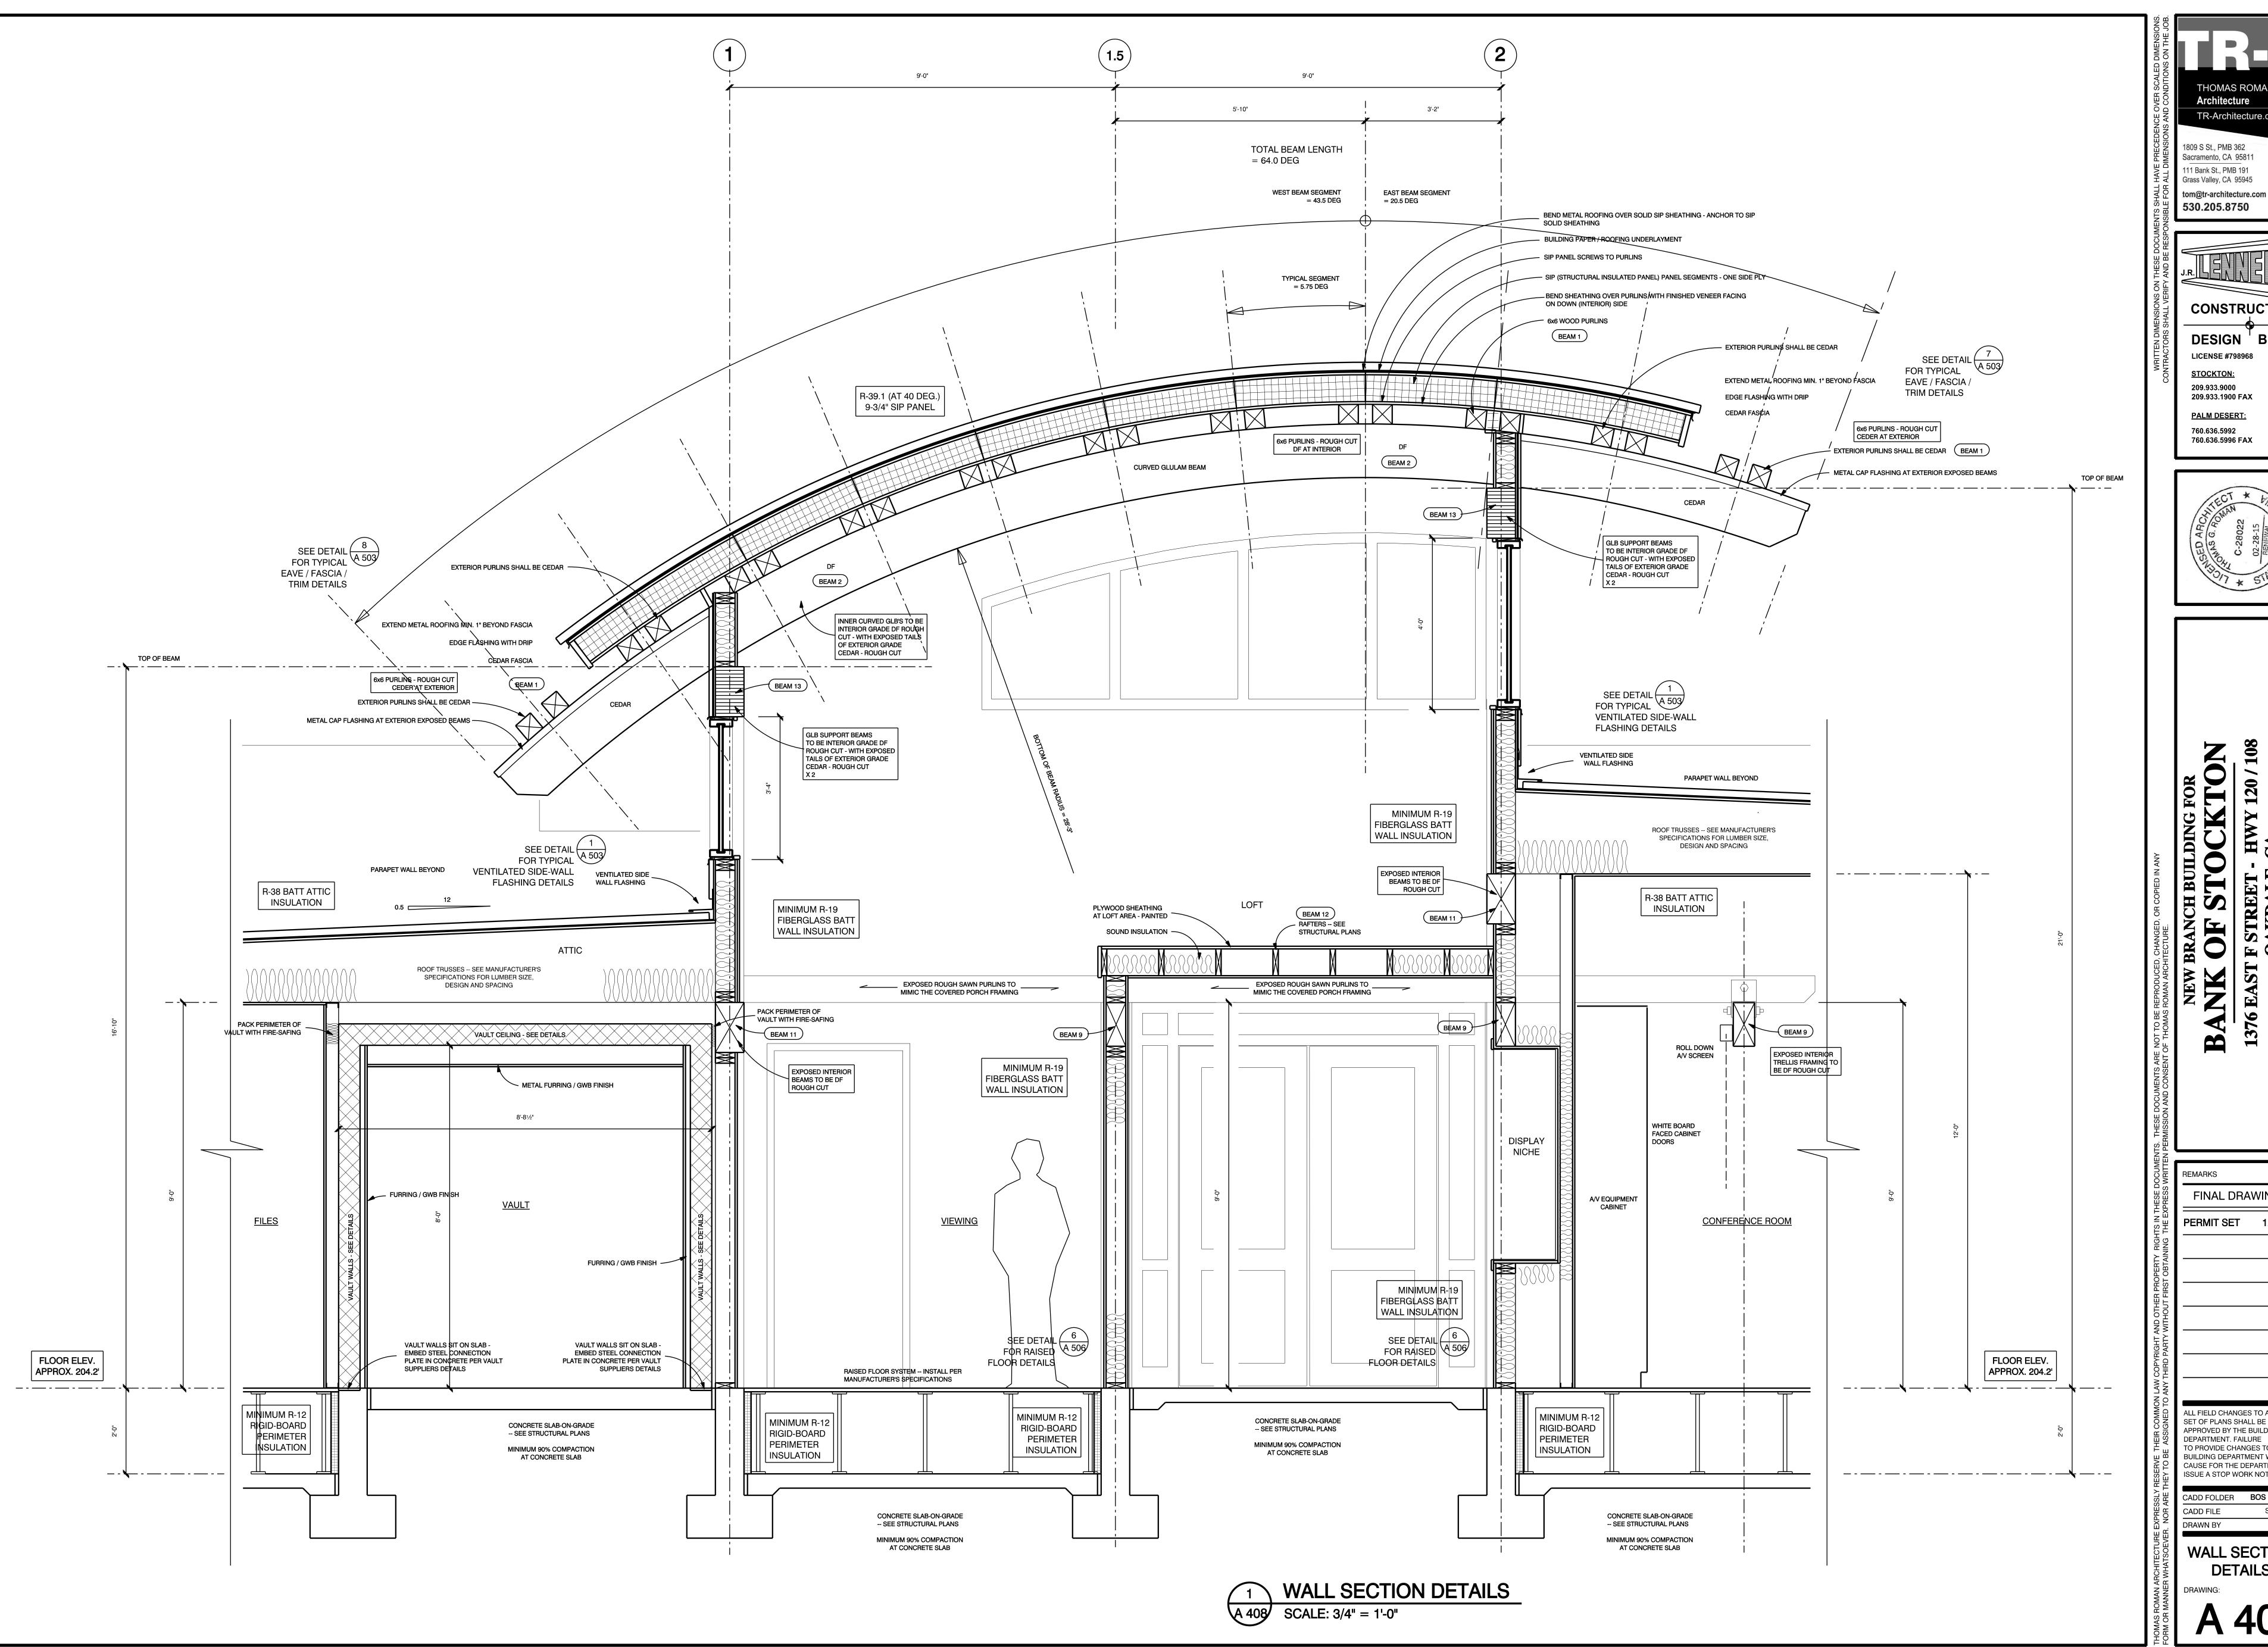

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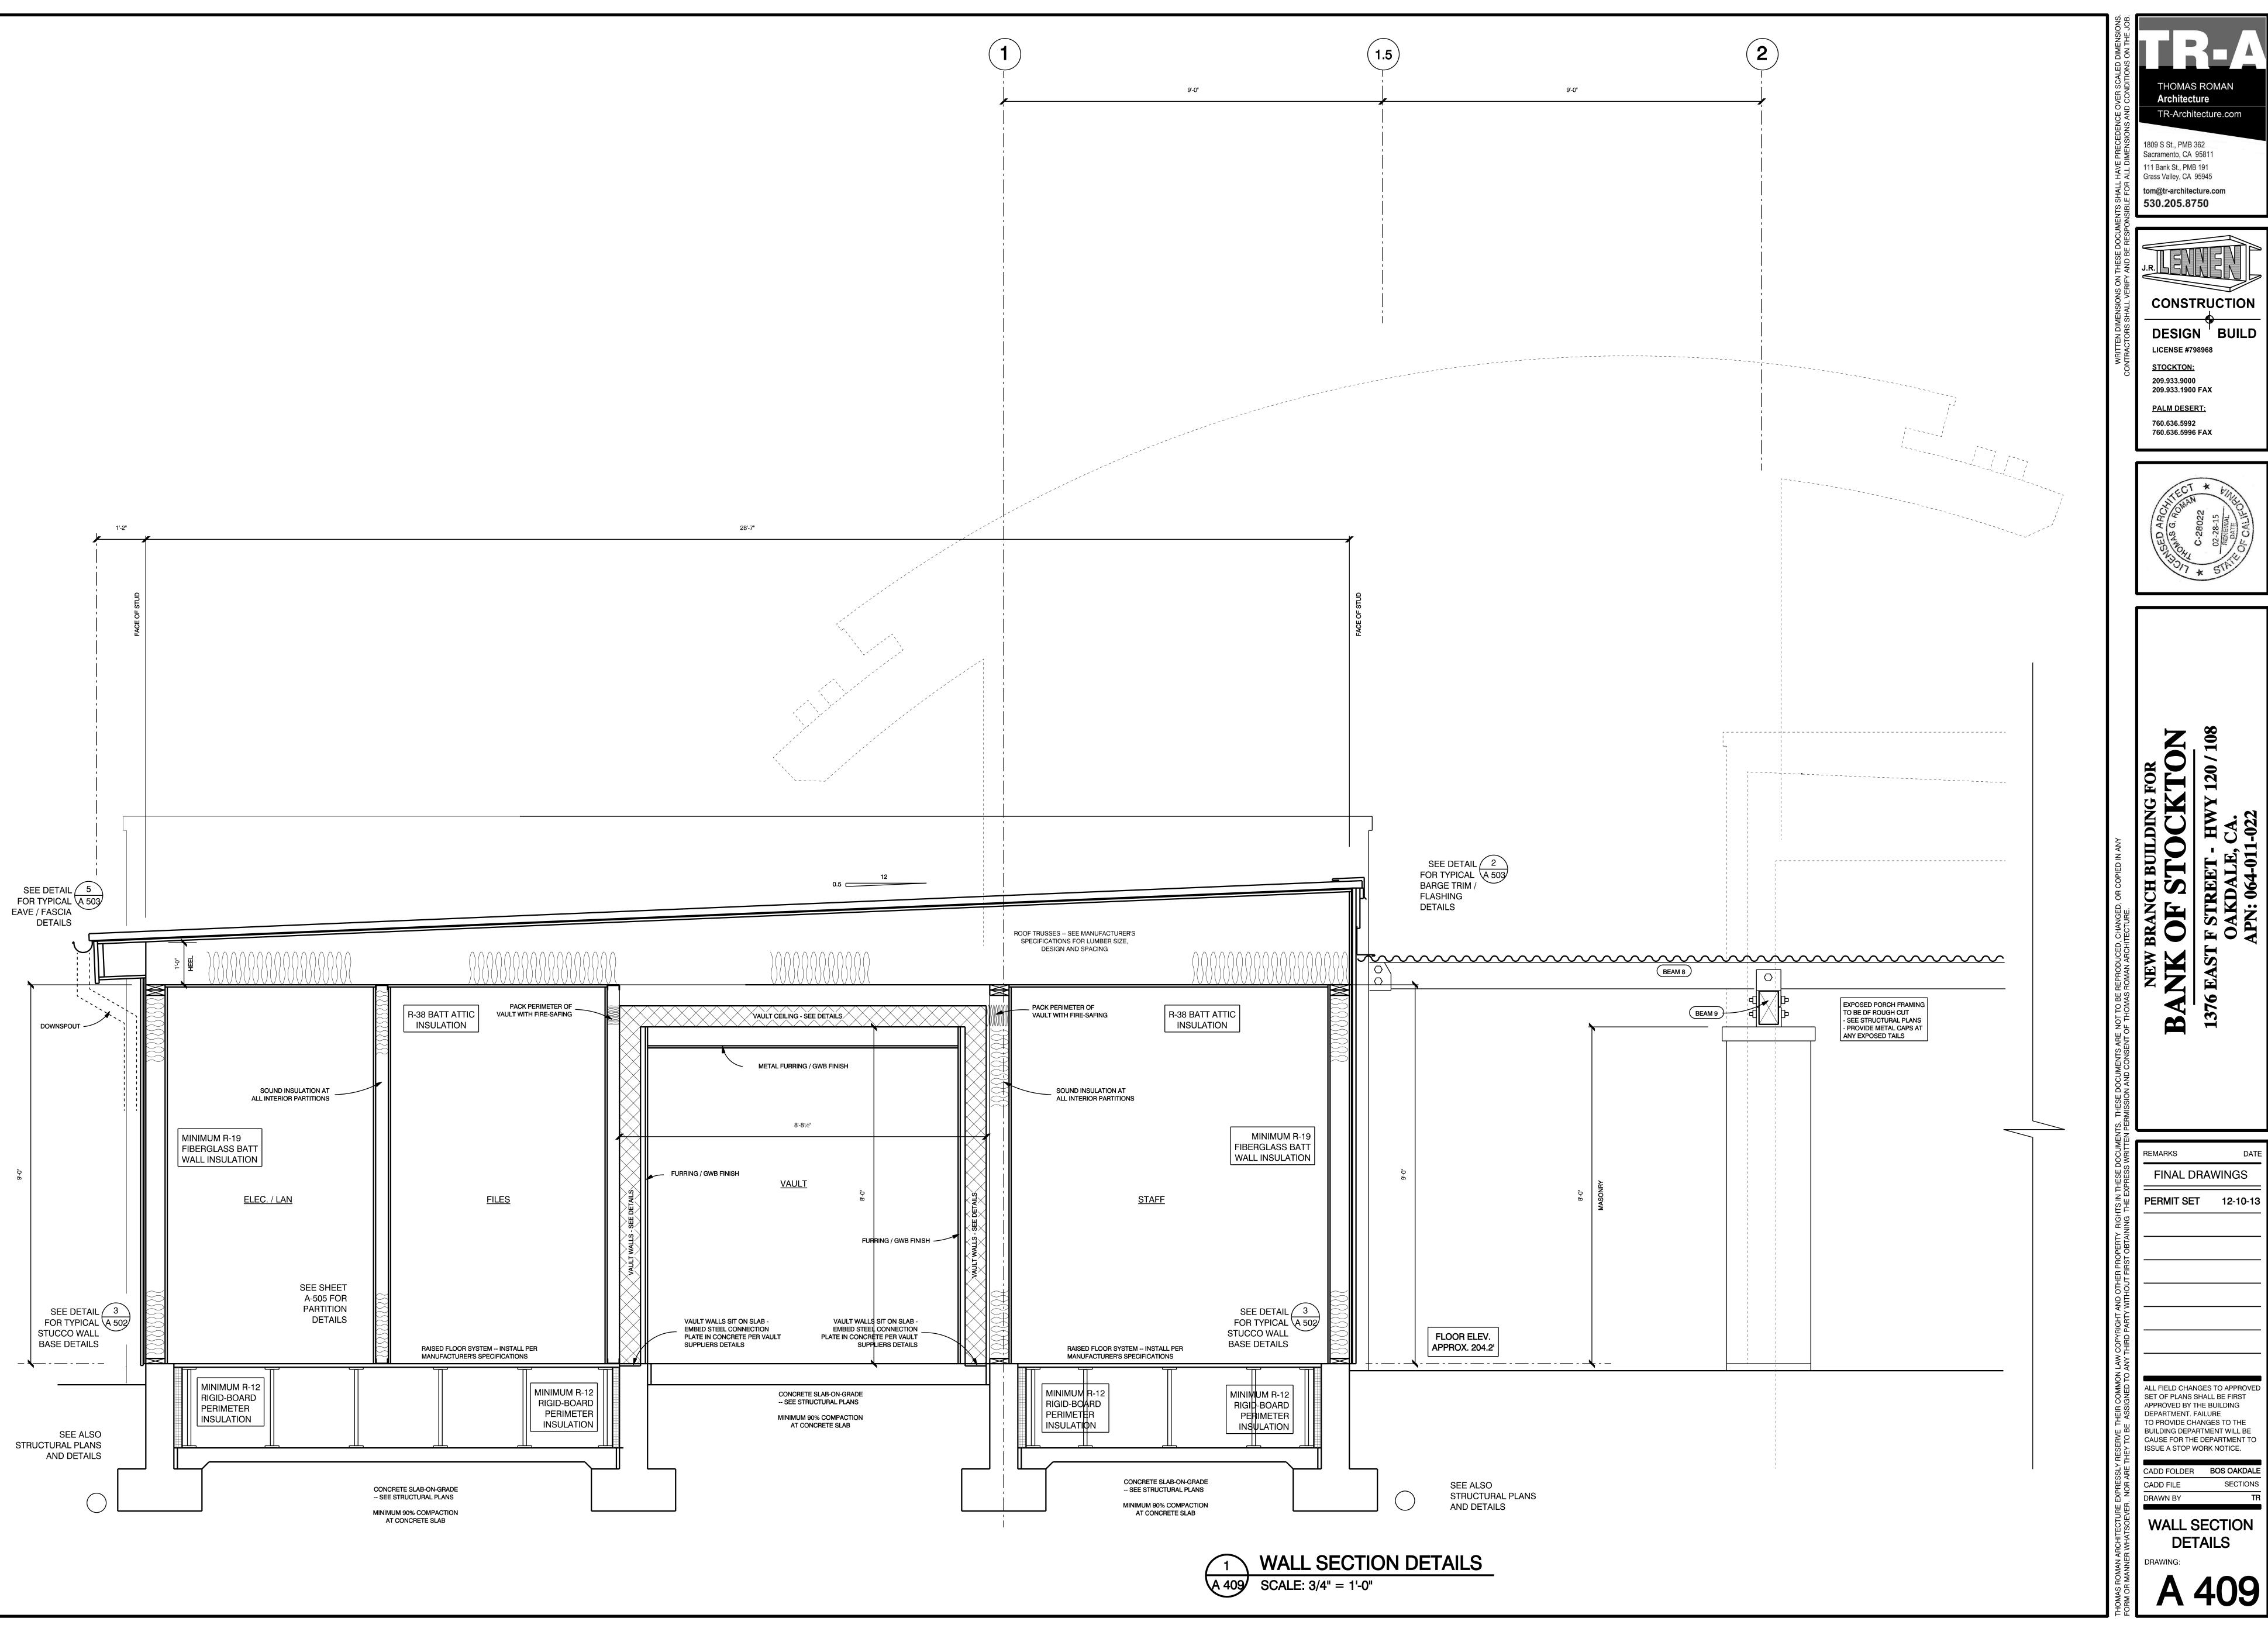



FINAL DRAWINGS PERMIT SET 12-10-13

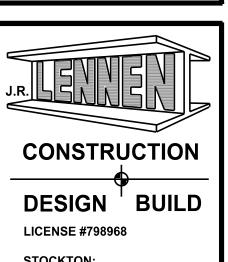
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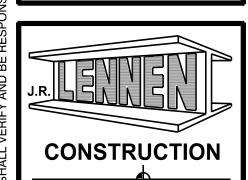
CADD FOLDER BOS OAKDALE

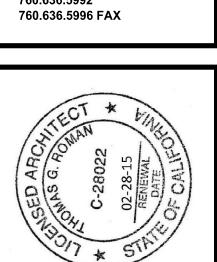WALL SECTION DETAILS





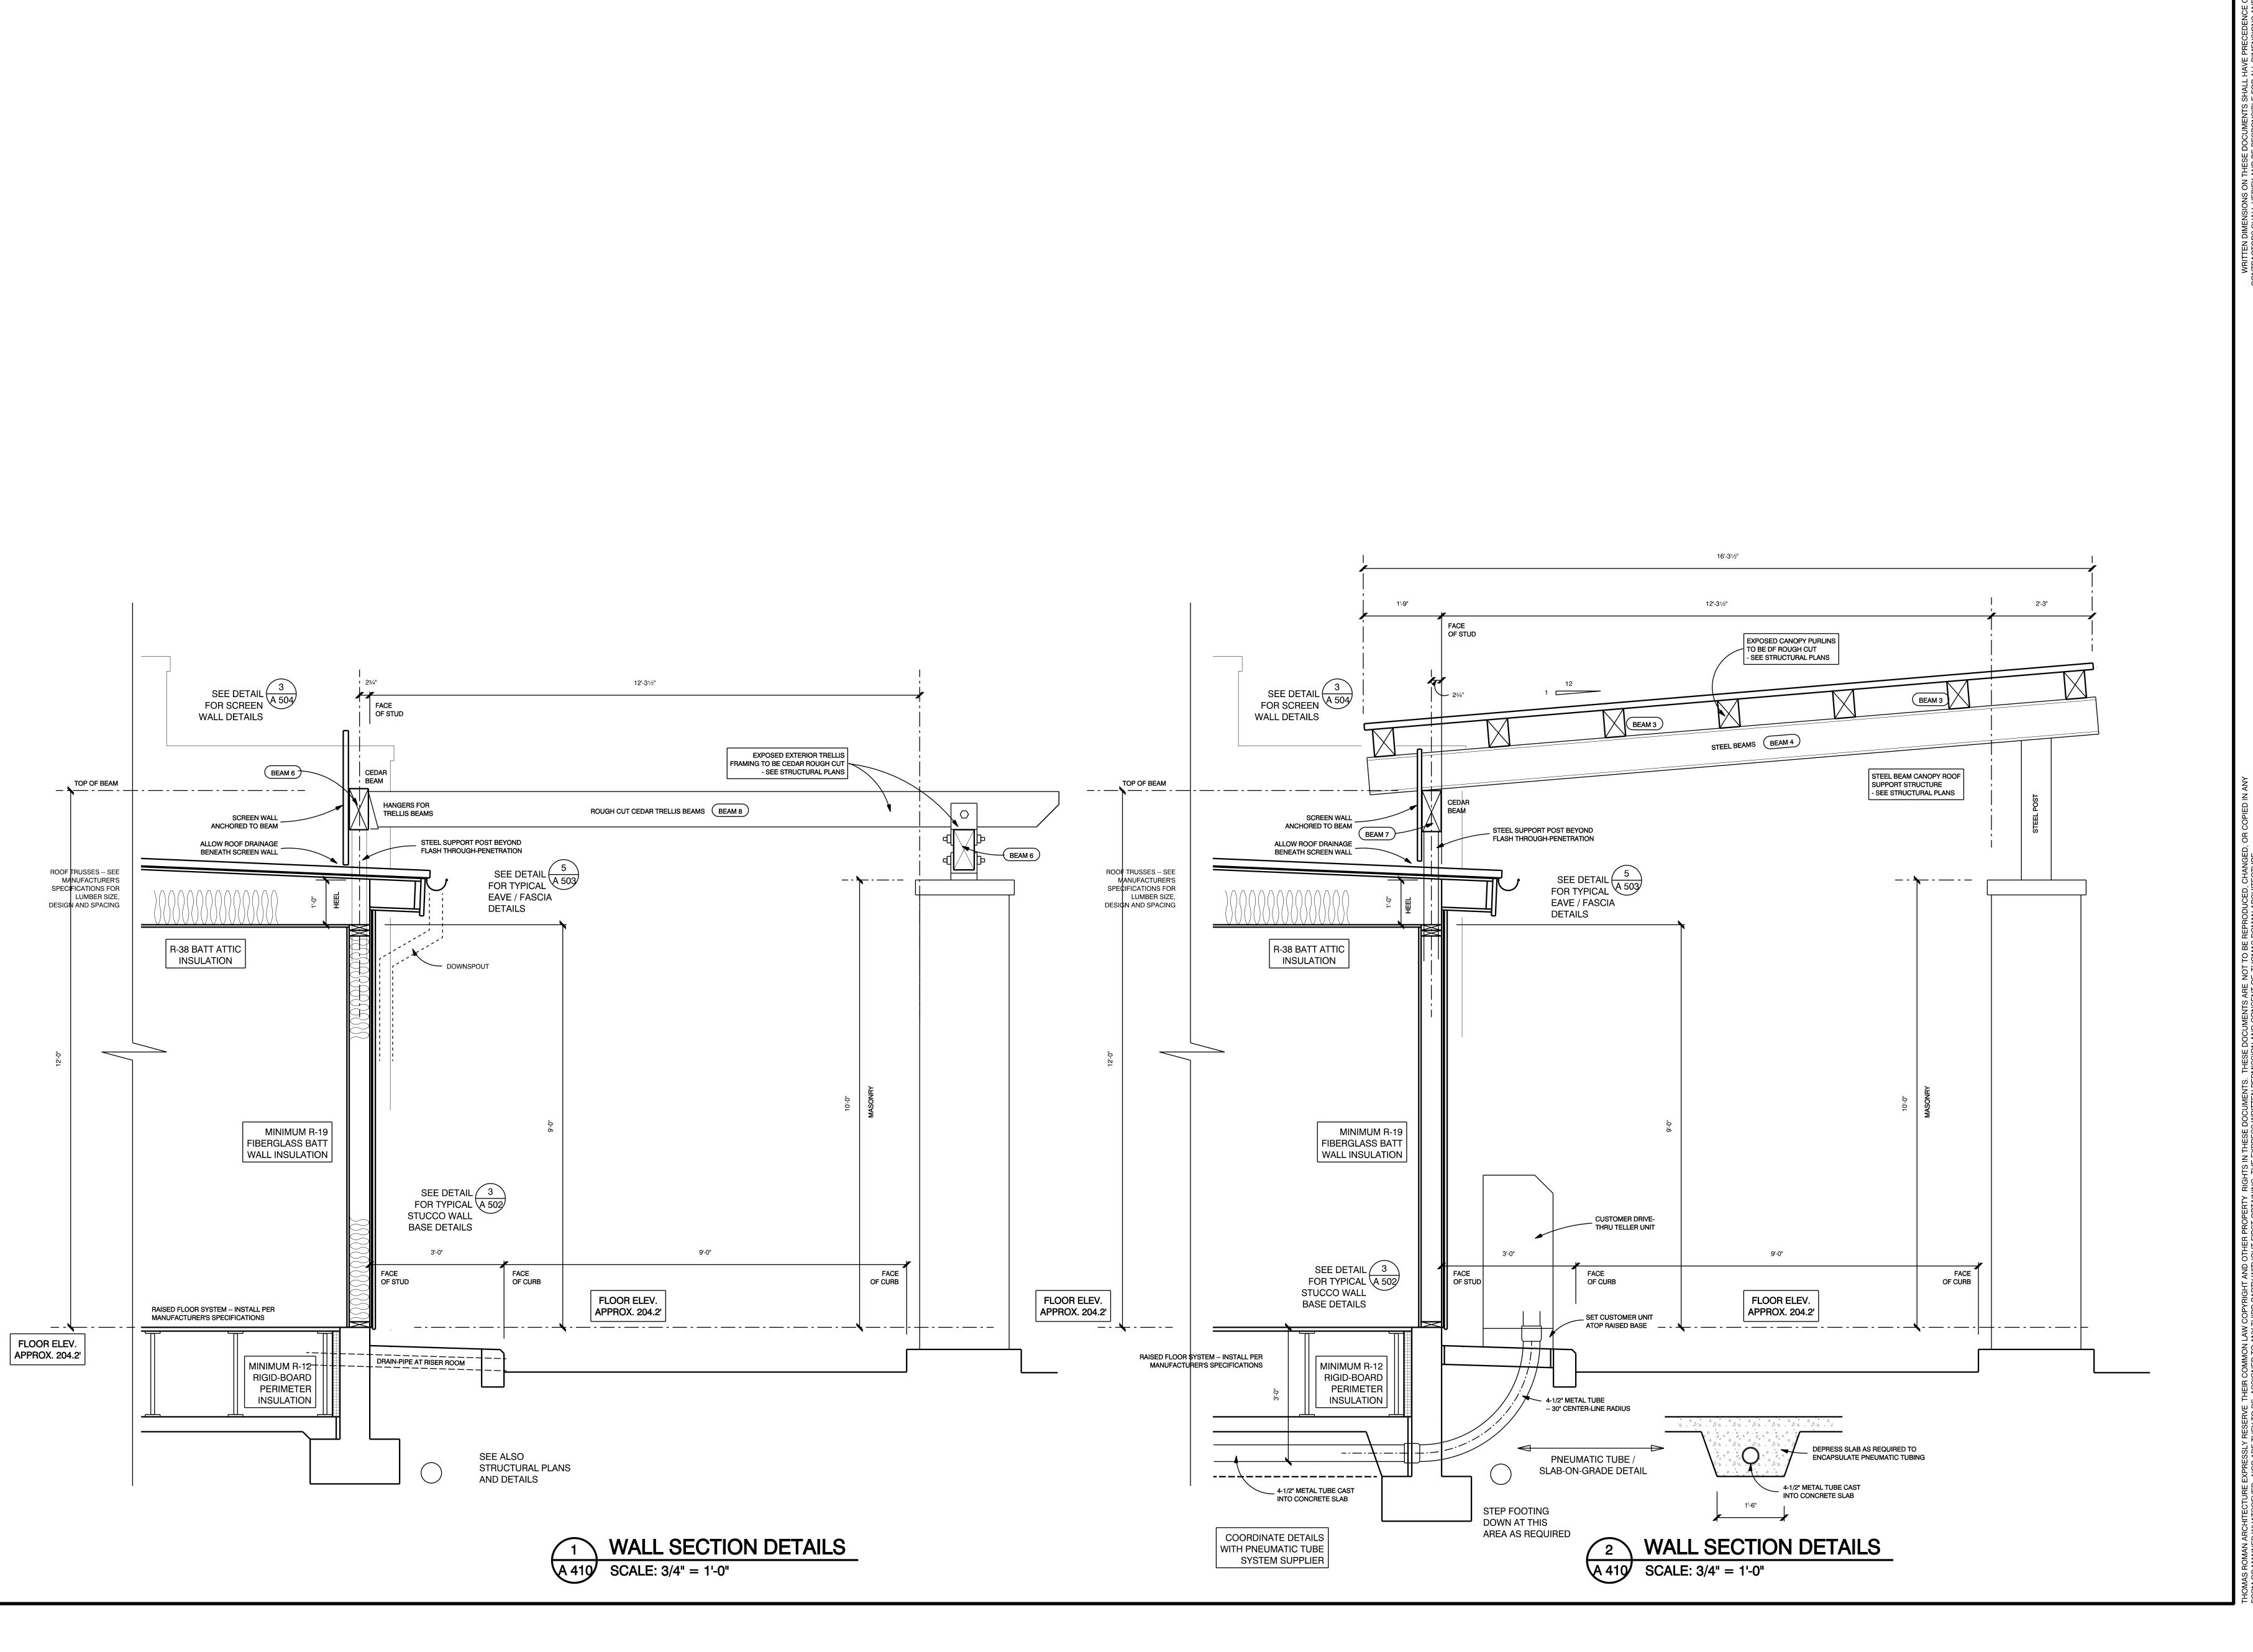


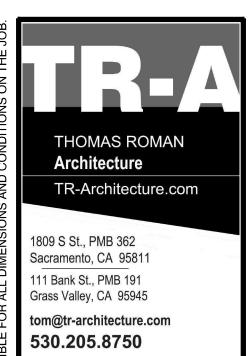

DESIGN BUILD LICENSE #798968

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BRANCH BUILDING FOR OF STOCKTON BANK


> REMARKS FINAL DRAWINGS PERMIT SET 12-10-13

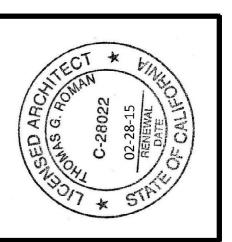ALL FIELD CHANGES TO APPROVED SET OF PLANS SHALL BE FIRST APPROVED BY THE BUILDING DEPARTMENT. FAILURE TO PROVIDE CHANGES TO THE BUILDING DEPARTMENT WILL BE CAUSE FOR THE DEPARTMENT TO

ISSUE A STOP WORK NOTICE. CADD FOLDER BOS OAKDALE CADD FILE SECTIONS DRAWN BY

WALL SECTION DETAILS

DRAWING:

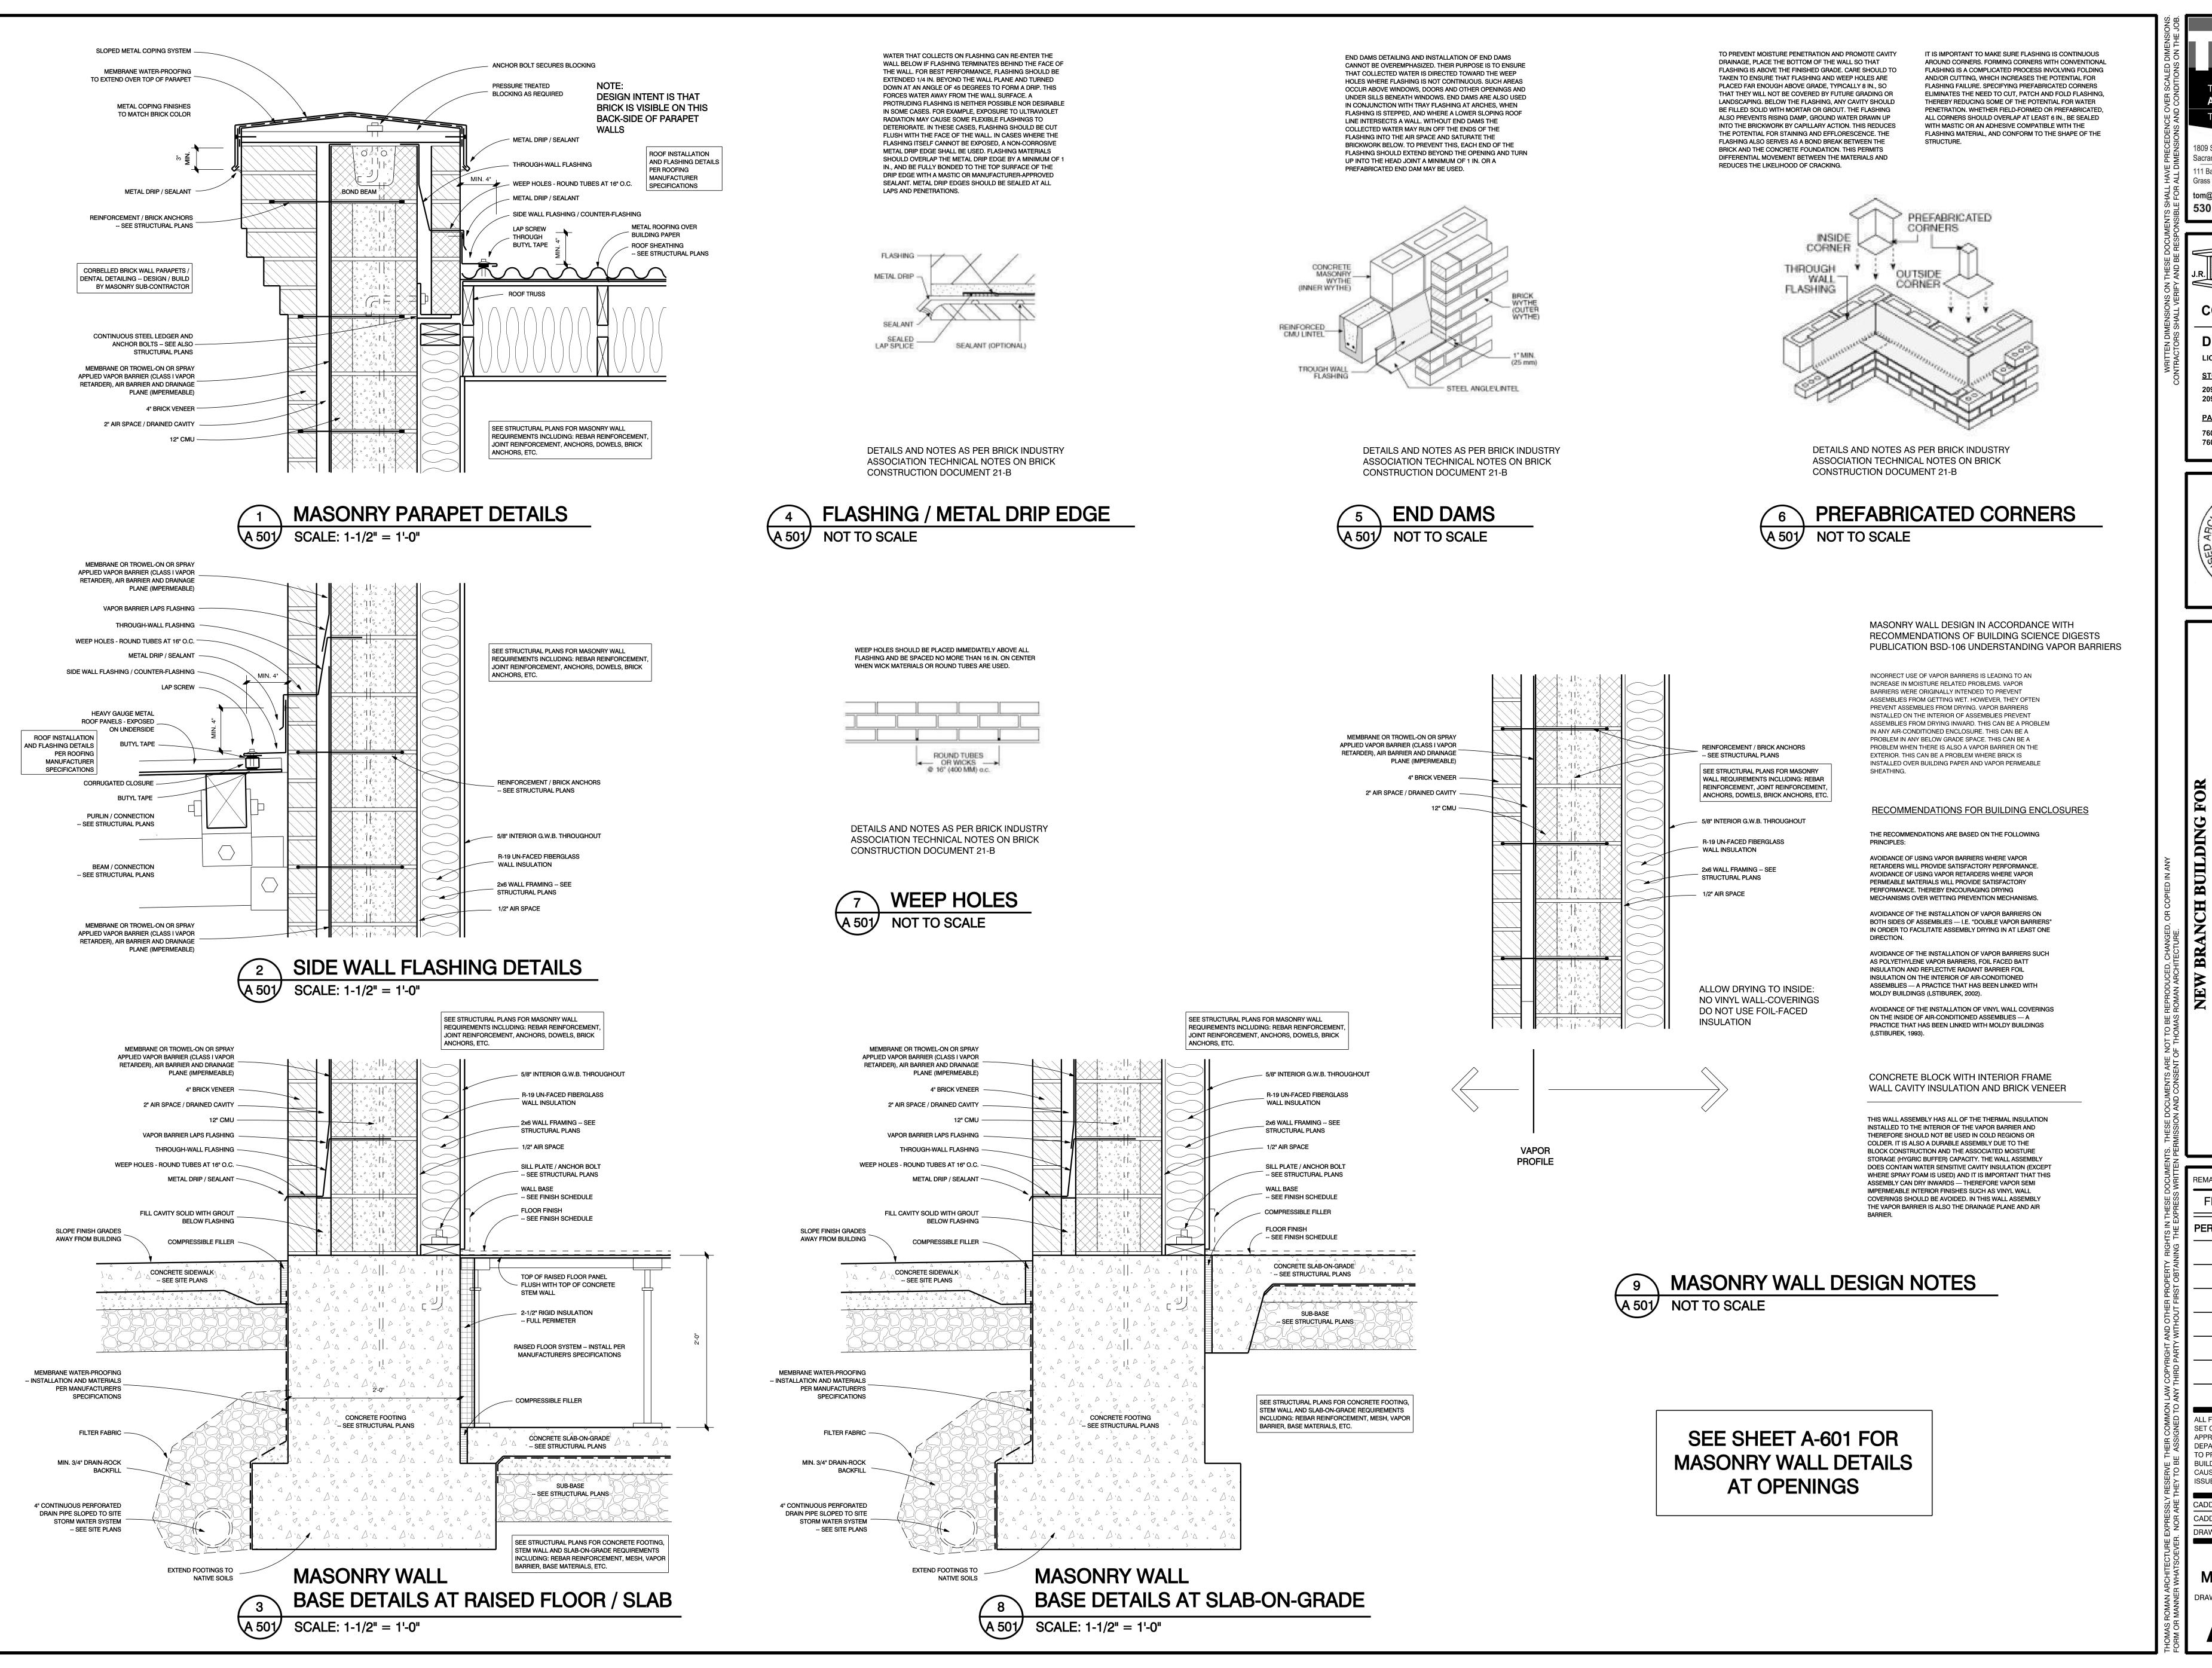


THOMAS ROMAN TR-Architecture.com 1809 S St., PMB 362 Sacramento, CA 95811 111 Bank St., PMB 191 Grass Valley, CA 95945 tom@tr-architecture.com

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FINAL DRAWINGS


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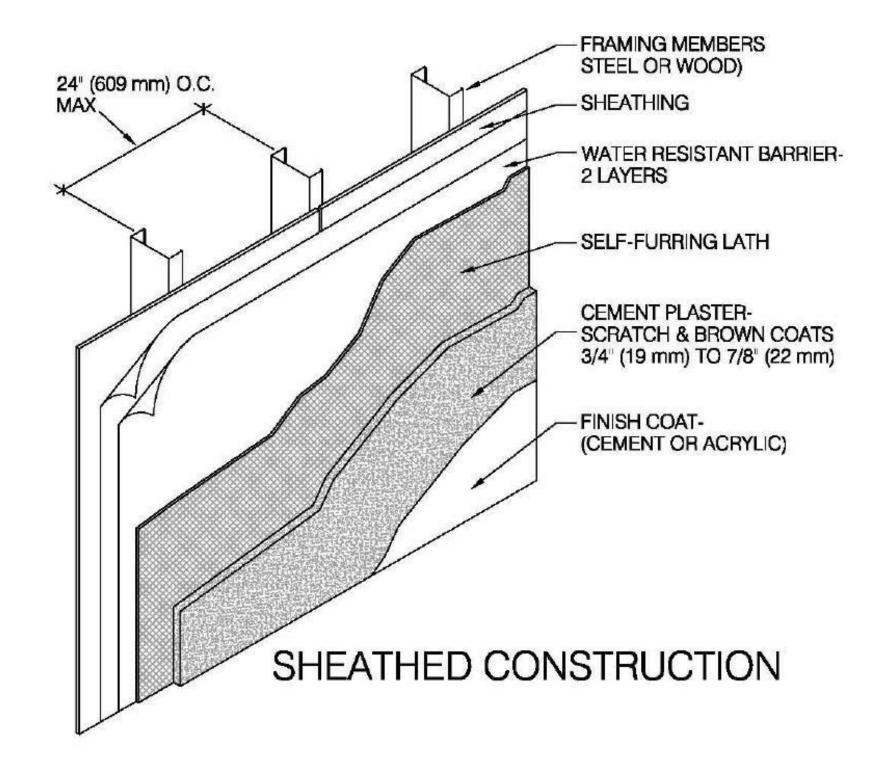
ALL FIELD CHANGES TO APPROVED

SET OF PLANS SHALL BE FIRST APPROVED BY THE BUILDING DEPARTMENT. FAILURE TO PROVIDE CHANGES TO THE **BUILDING DEPARTMENT WILL BE** CAUSE FOR THE DEPARTMENT TO ISSUE A STOP WORK NOTICE.

CADD FOLDER BOS OAKDALE CADD FILE DRAWN BY

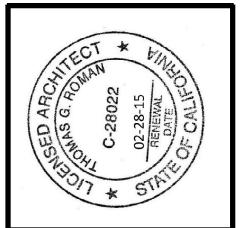
MASONRY / MISC. DETAILS



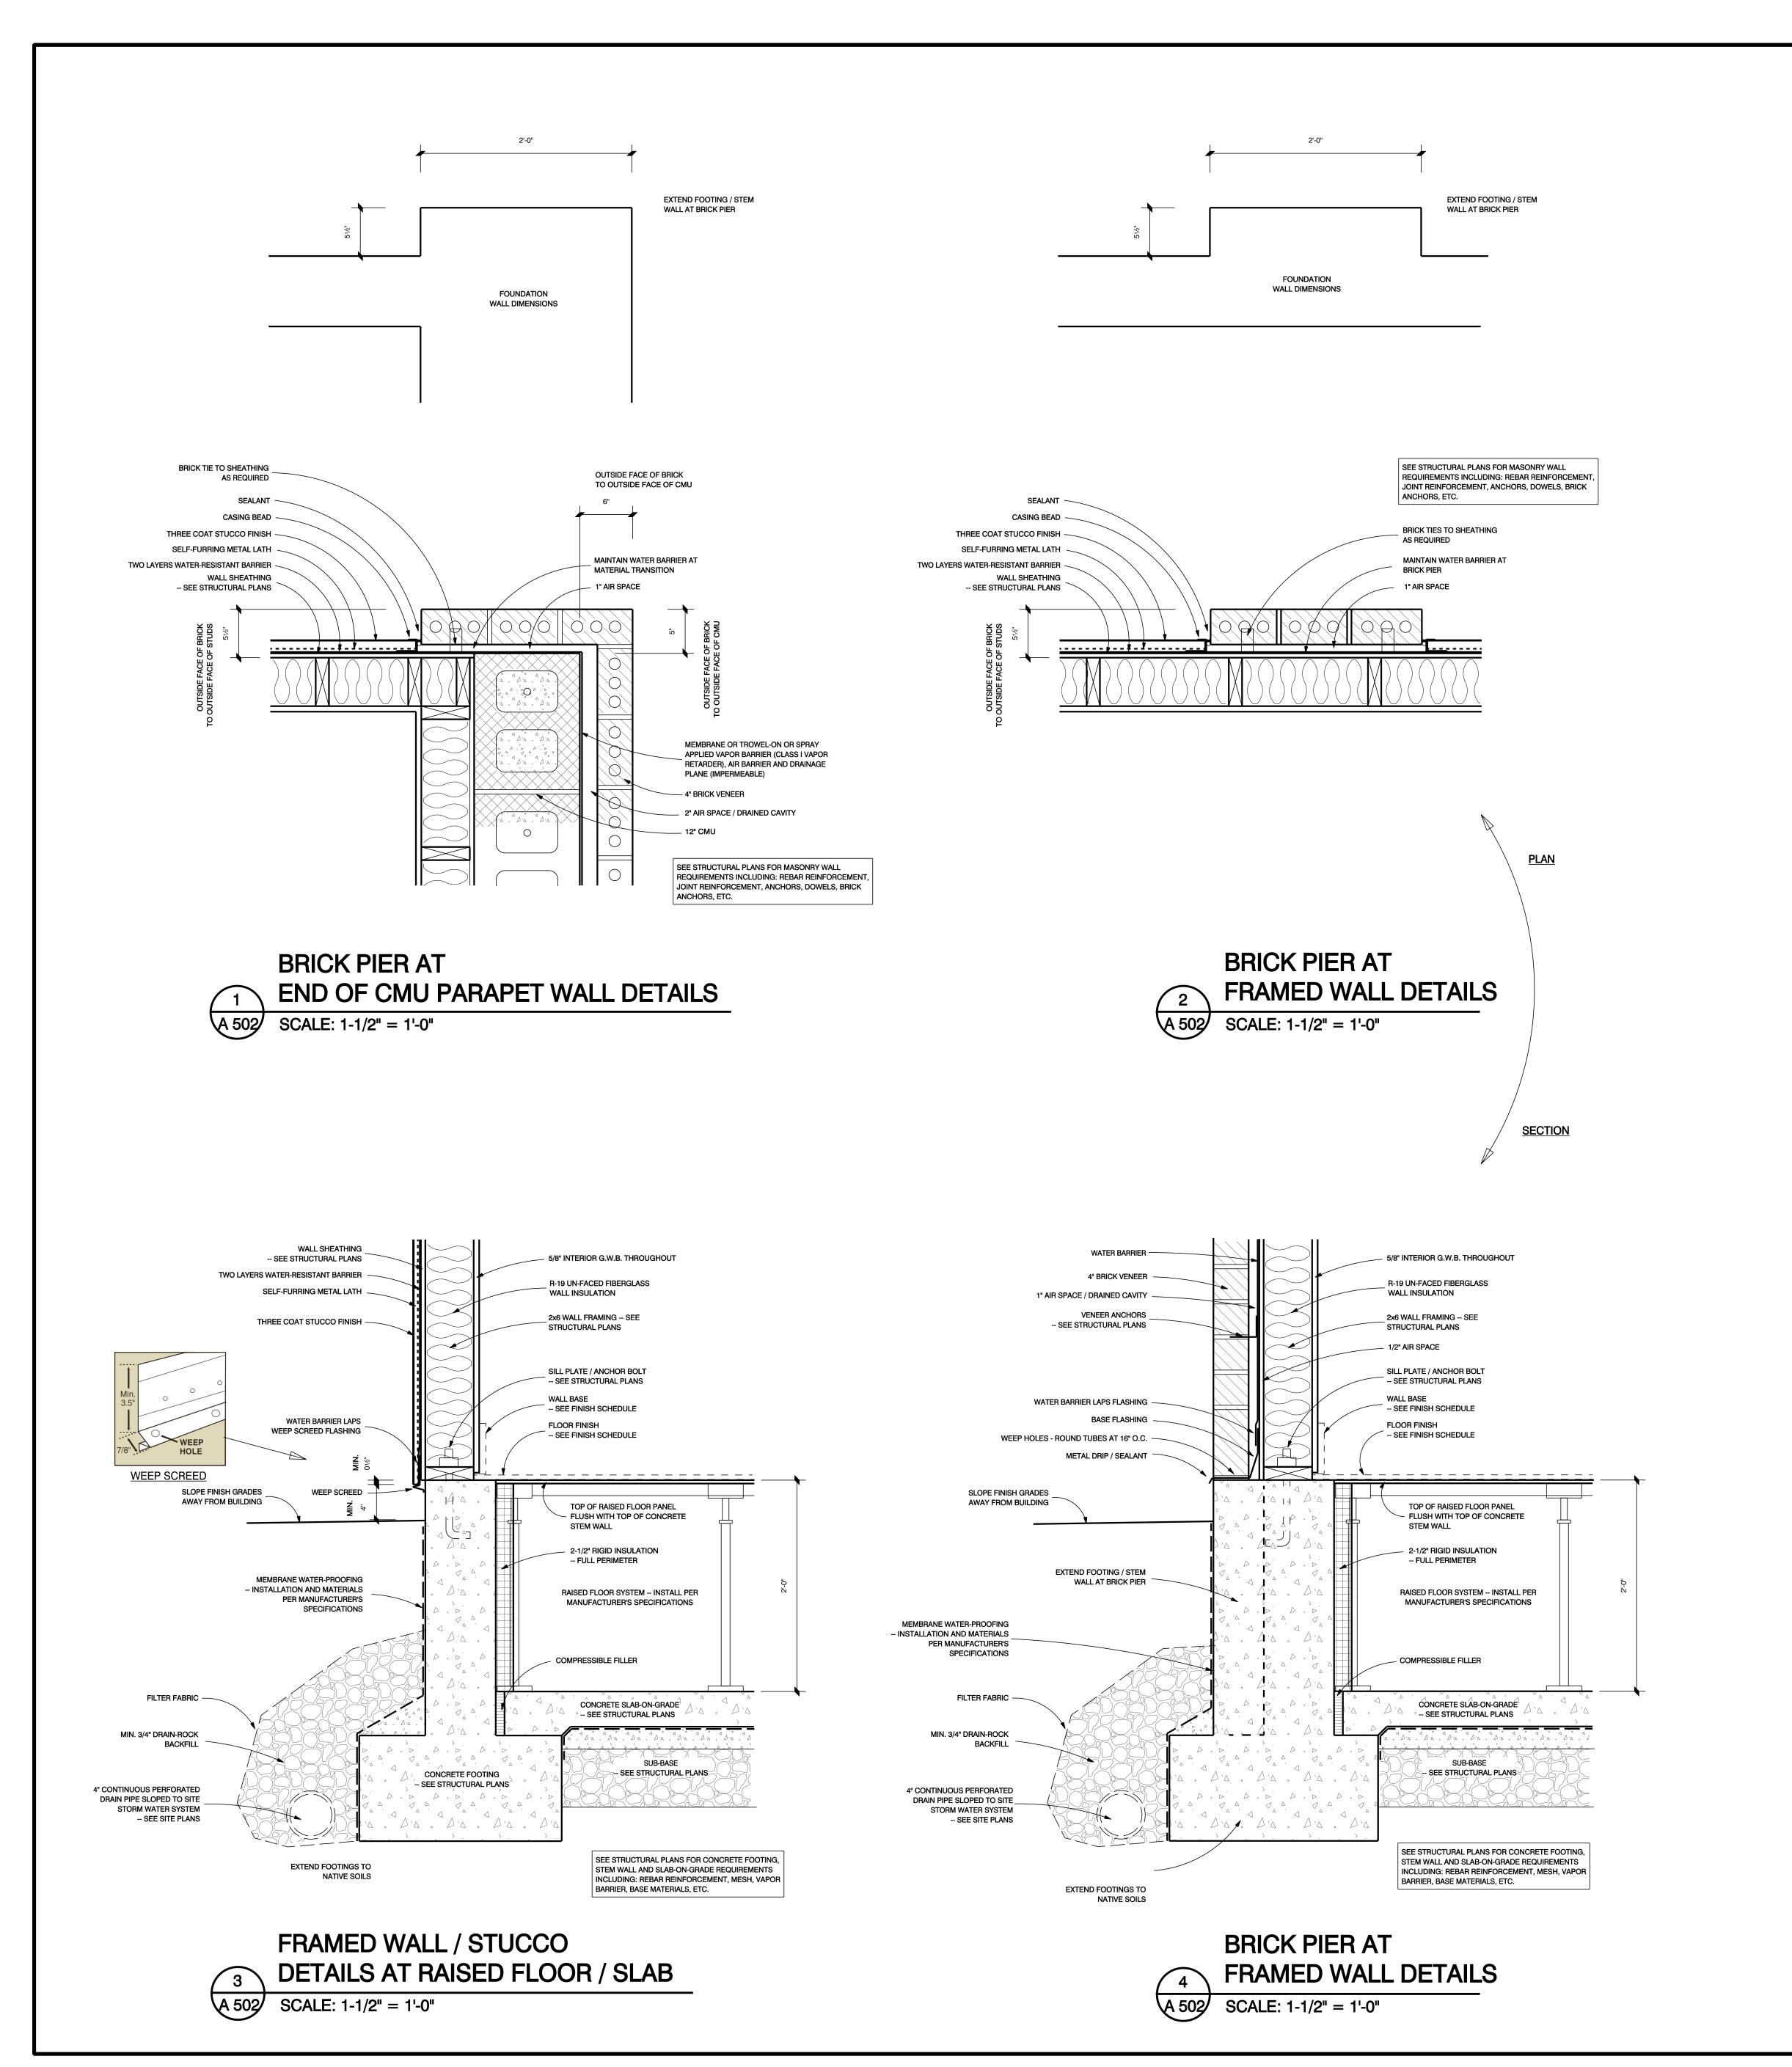

3-COAT STUCCO WALL FINISH


NOT TO SCALE

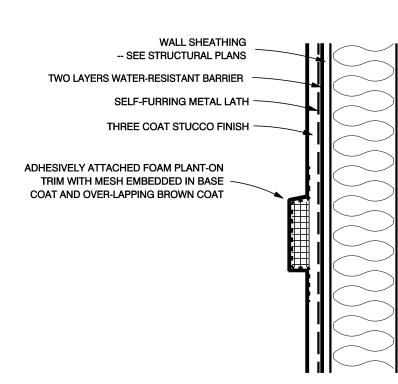


STUCCO WALL TRIM DETAIL

A 502 NOT TO SCALE

SEE SHEET A-601 FOR STUCCO WALL DETAILS AT OPENINGS

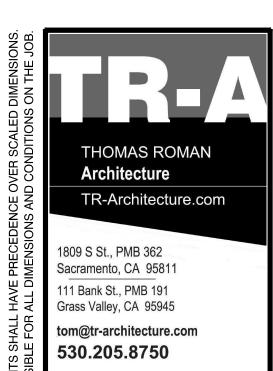

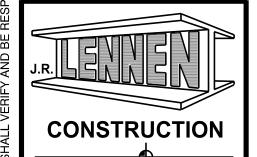

DESIGN BUILD

LICENSE #798968


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209.933.9000
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PALM DESERT:

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NG FOR MG FOR VY 120 / 108


ANK OF STOCKT(76 EAST F STREET - HWY 120 OAKDALE, CA.


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APPROVED BY THE BUILDING
DEPARTMENT. FAILURE
TO PROVIDE CHANGES TO THE
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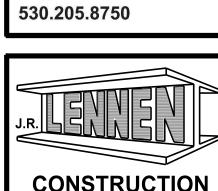
CADD FOLDER BOS OAKDALI
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STUCCO / MISC. DETAILS




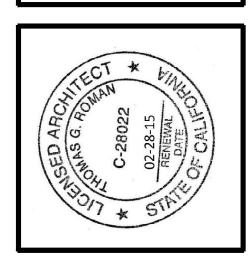

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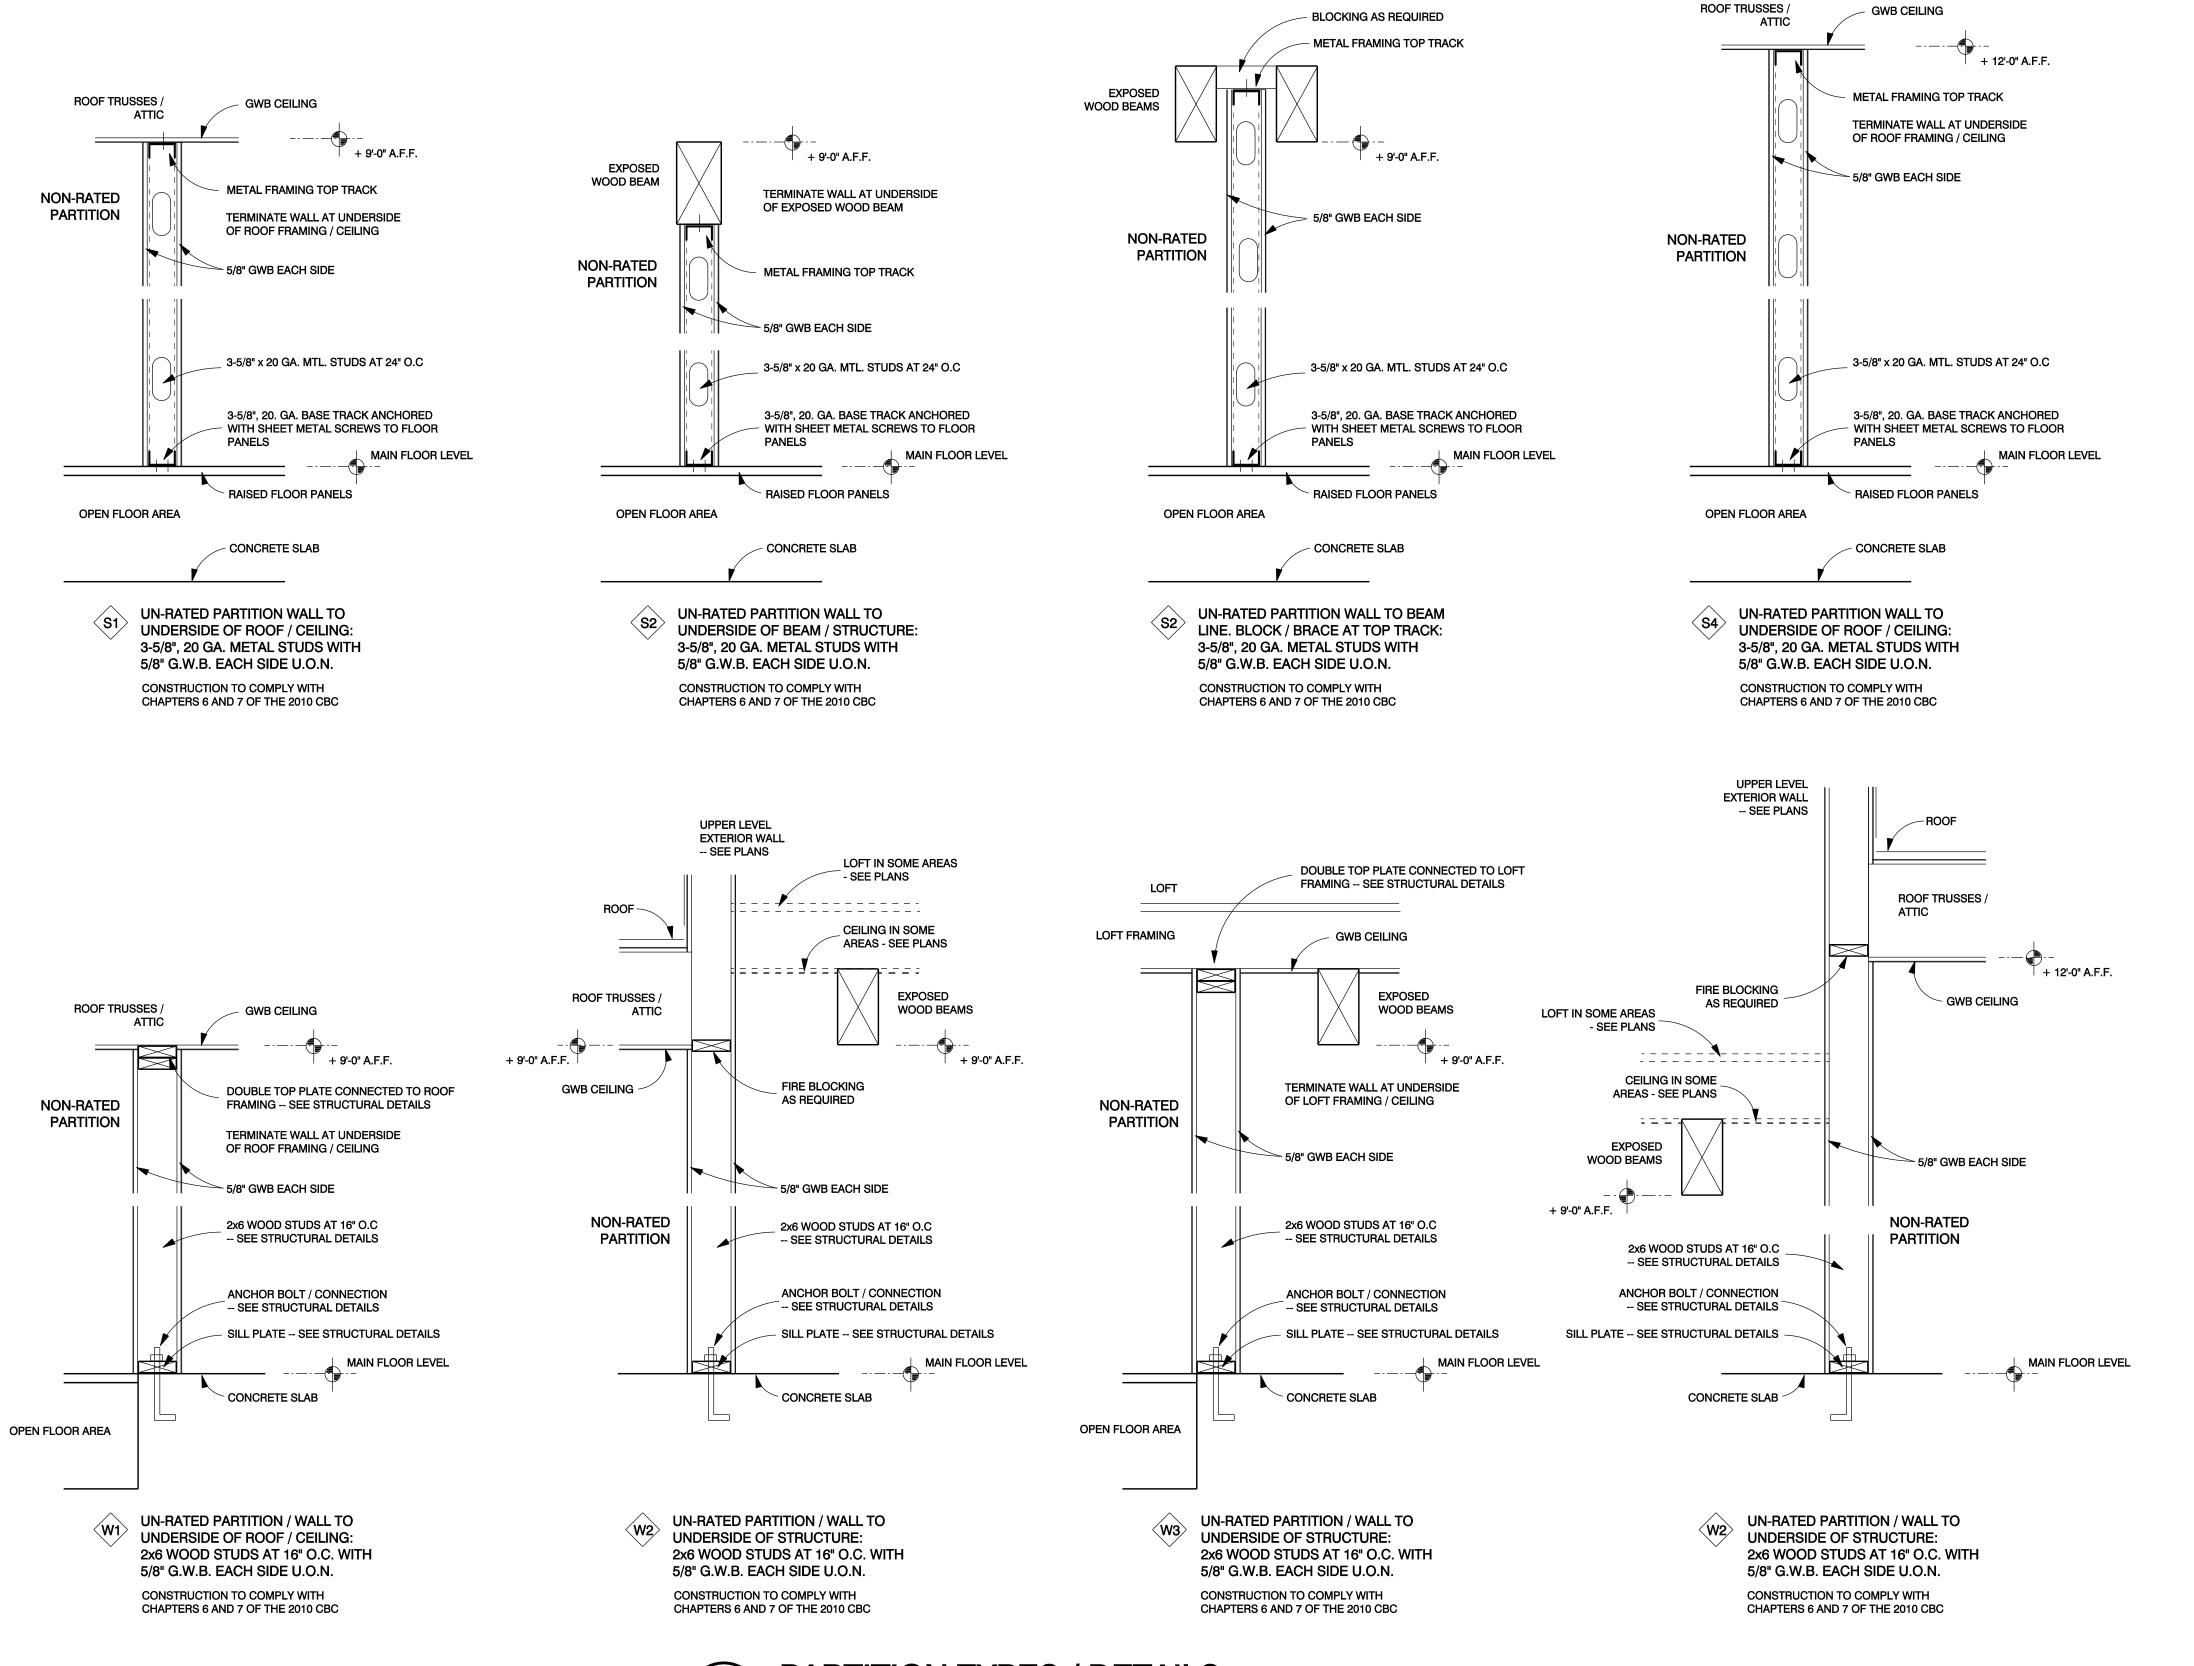


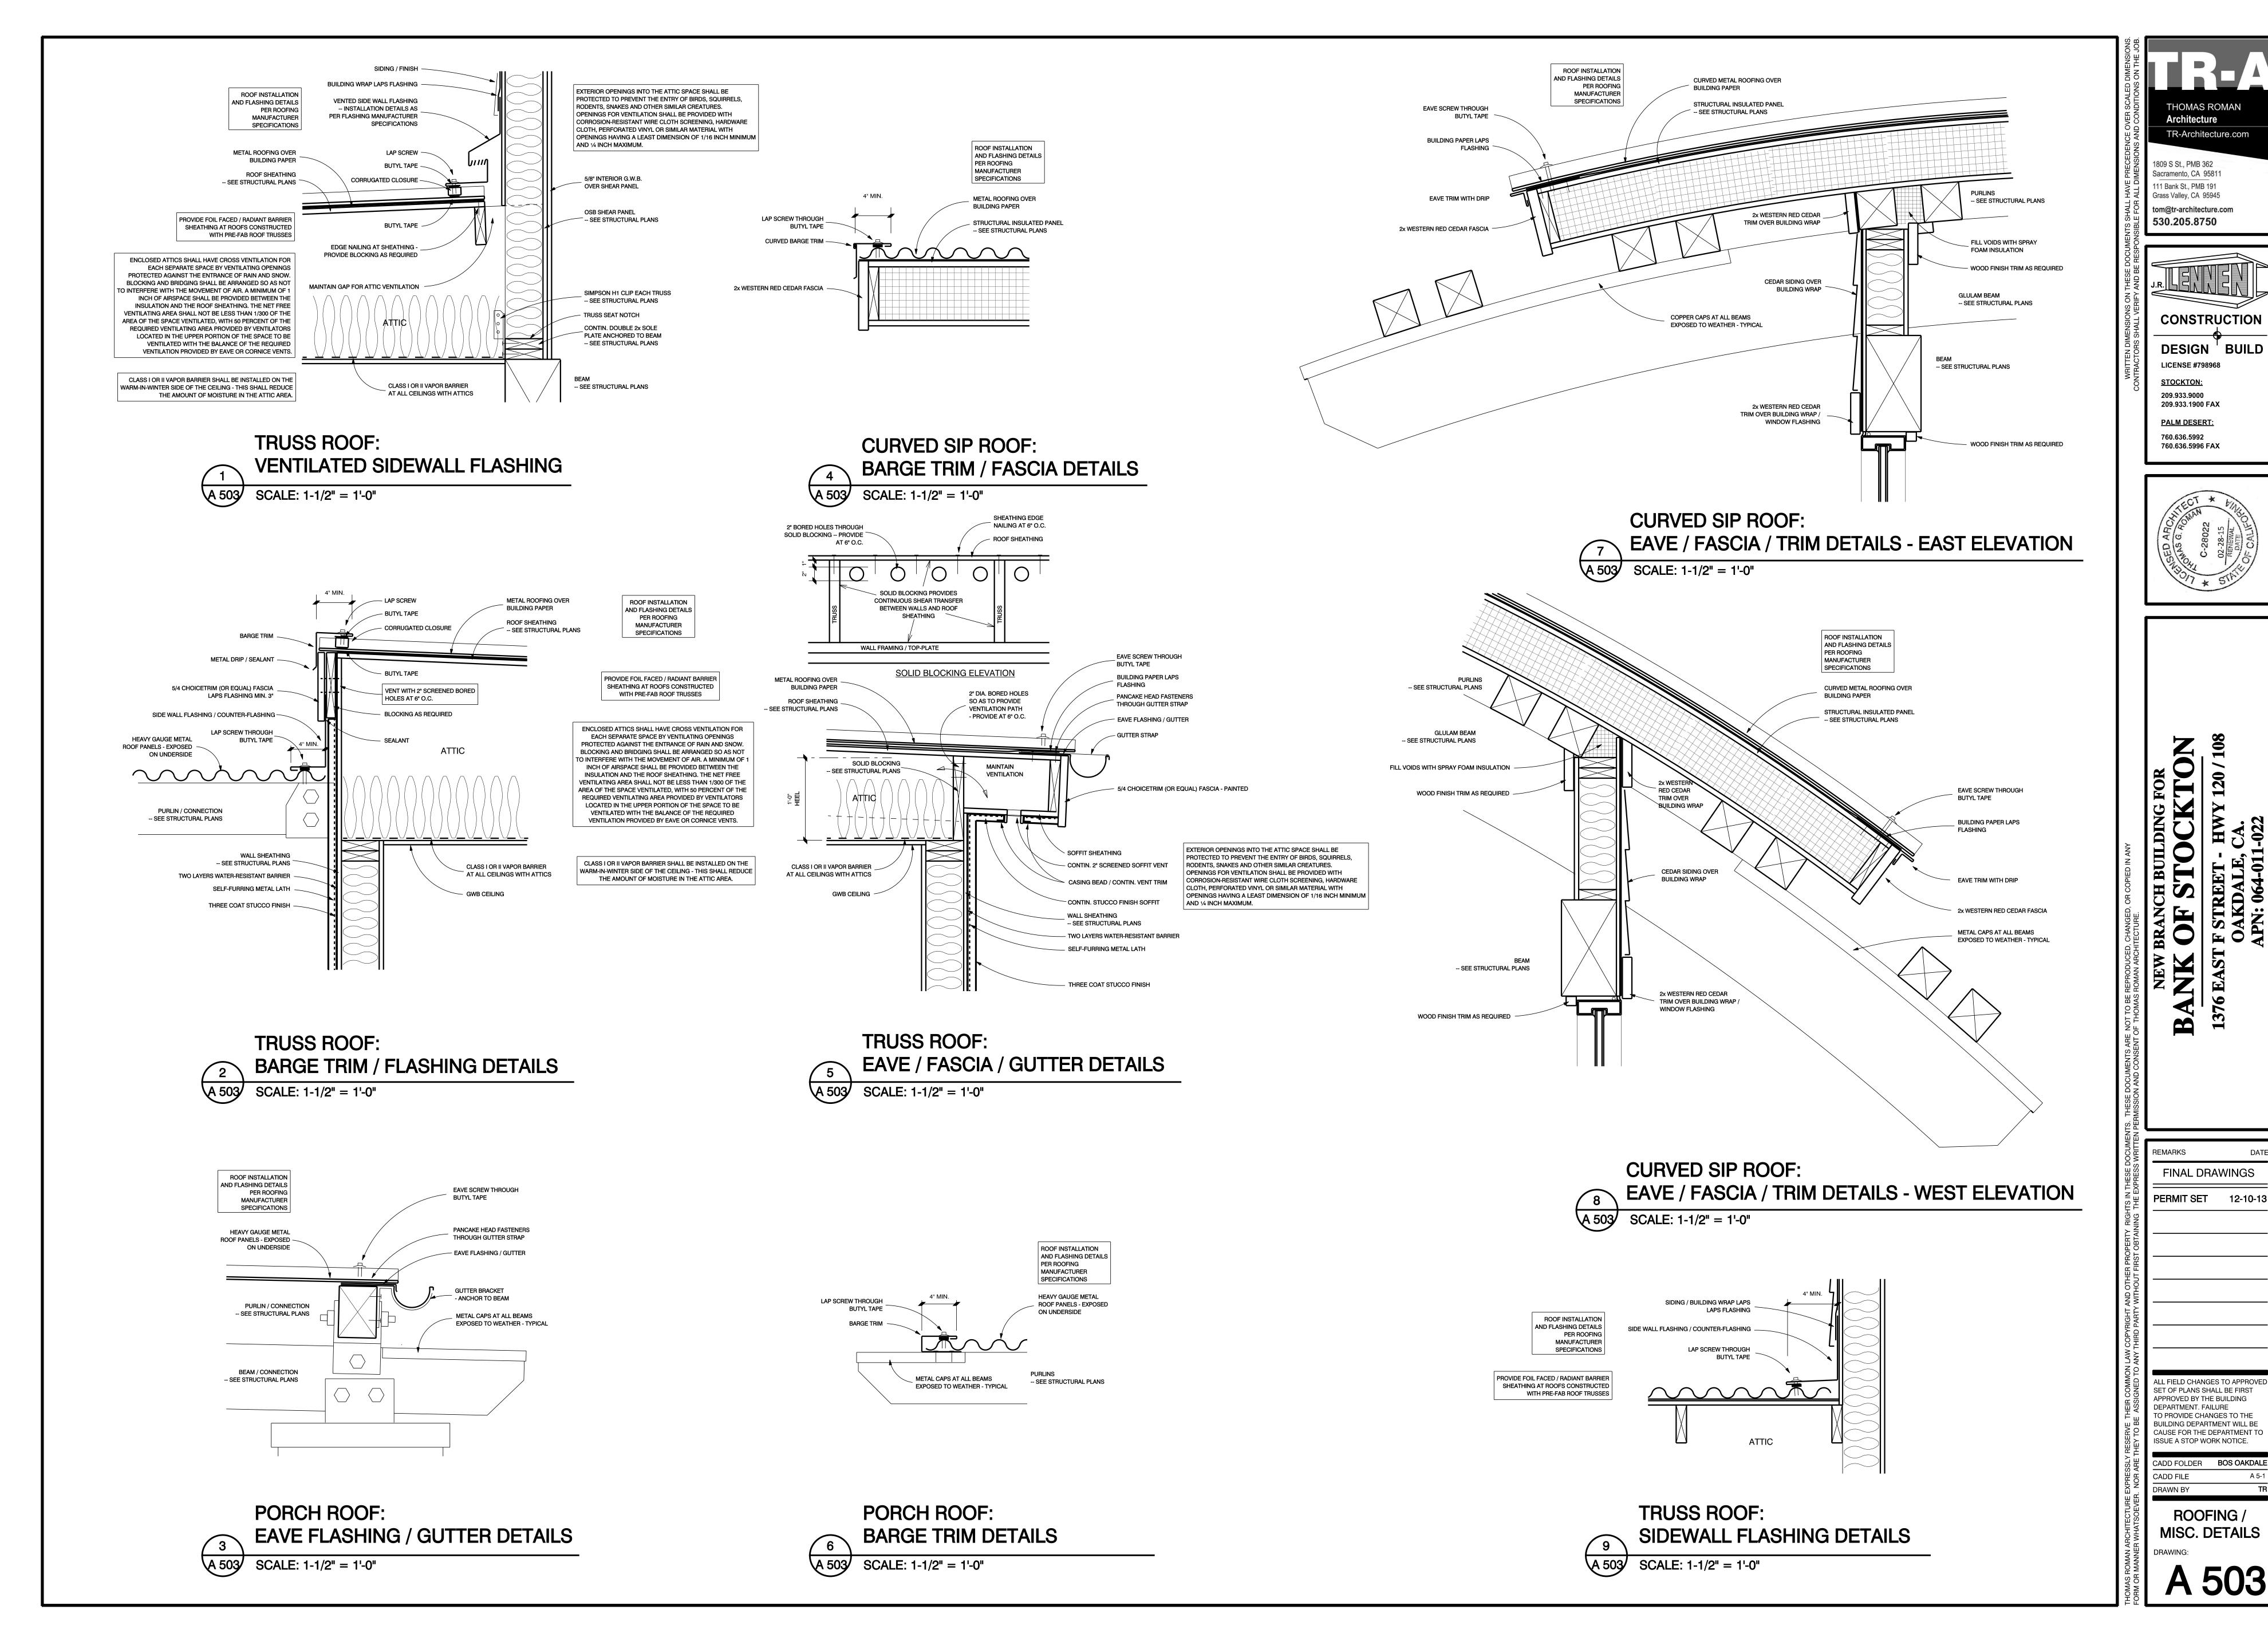
FINAL DRAWINGS PERMIT SET 12-10-13
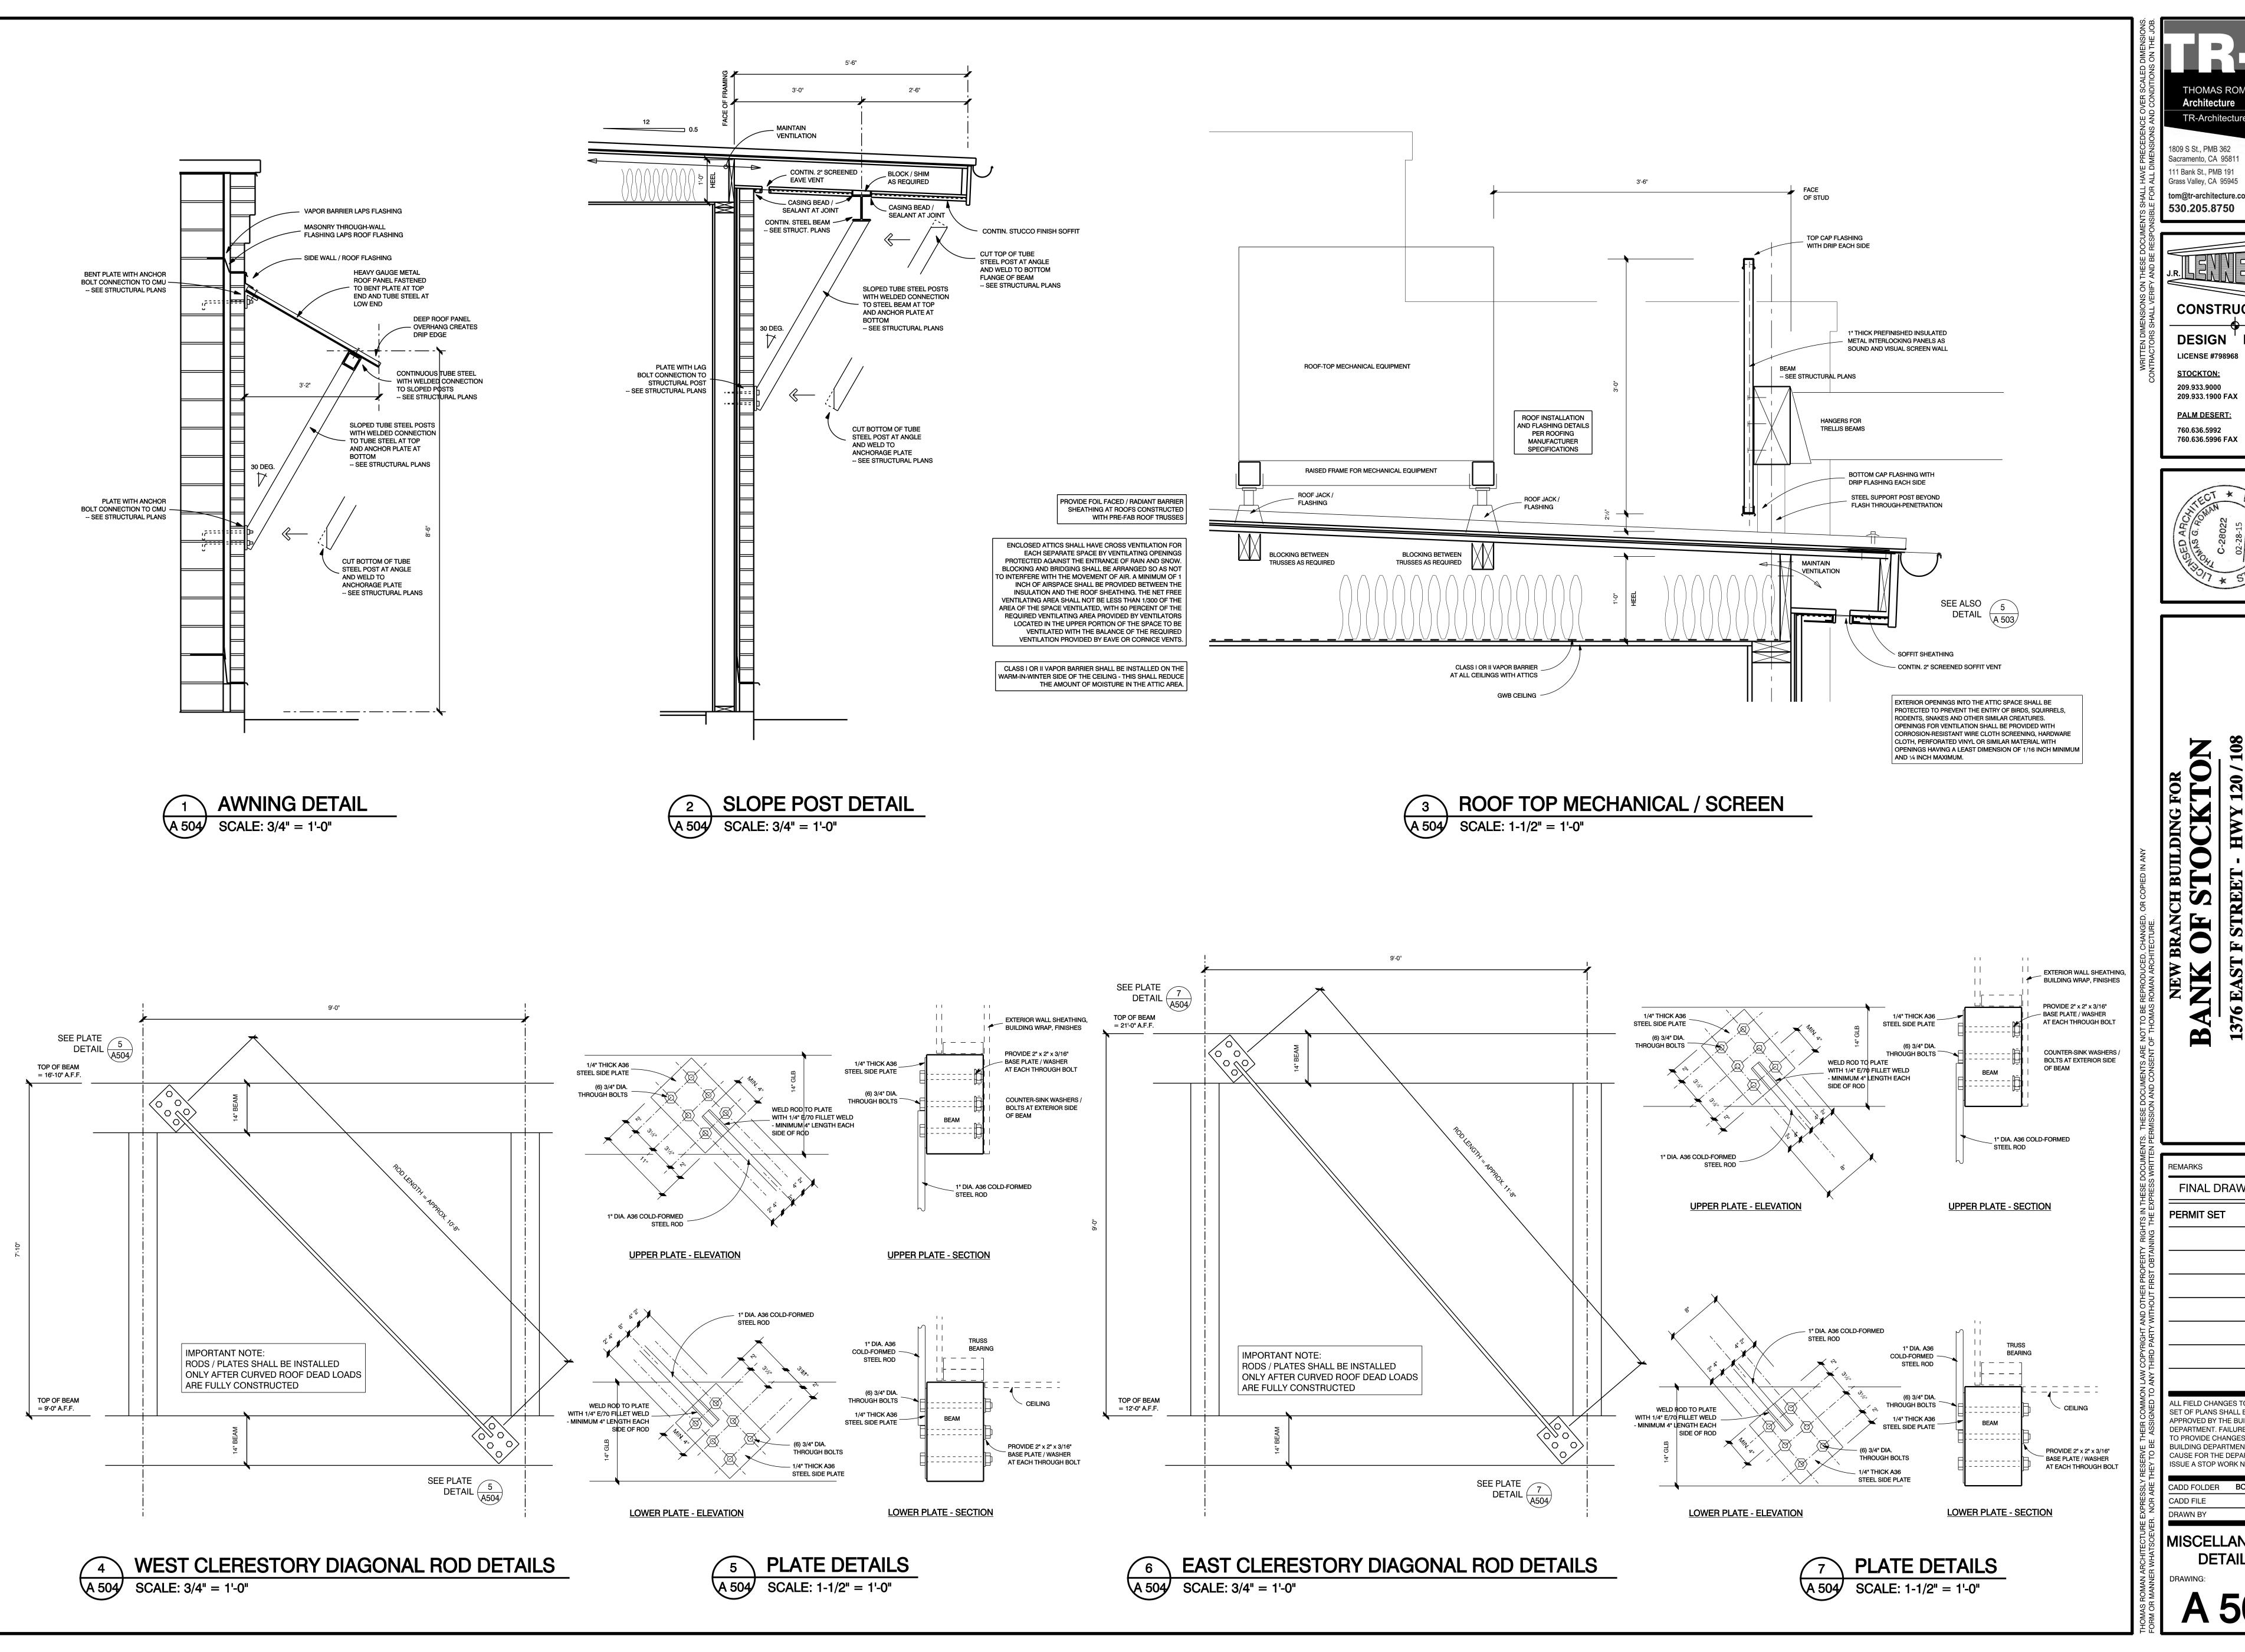
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CADD FOLDER BOS OAKDALE DRAWN BY

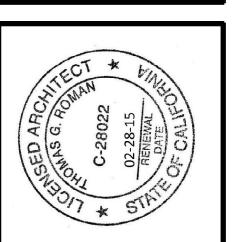
MISCELLANEOUS **DETAILS**






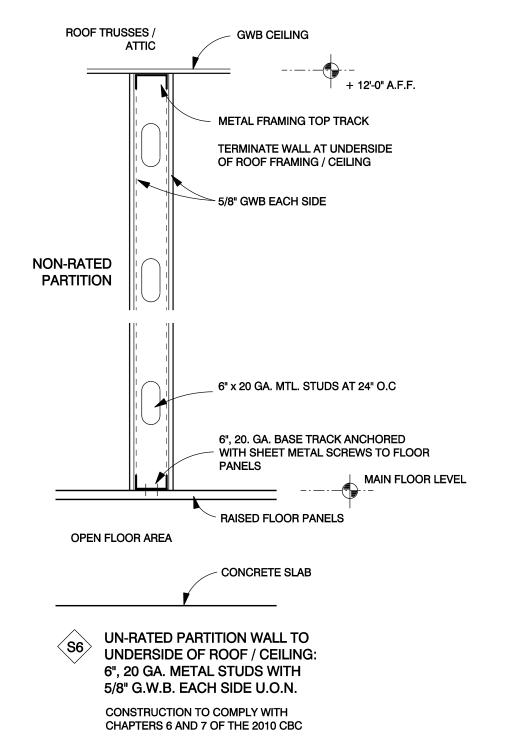


ALL DRYWALL SHALL BE 5/8" GWB. CONSTRUCTION TO COMPLY WITH THE REQUIREMENTS OF CHAPTERS 6 AND 7 OF THE 2010 CALIFORNIA BUILDING CODE.

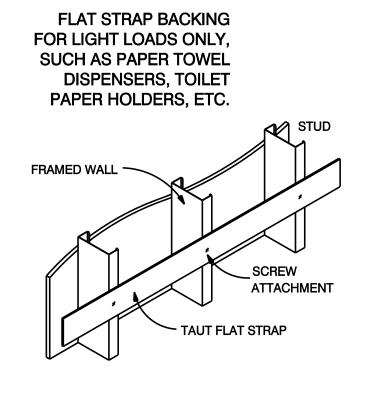


STRAP BACKING

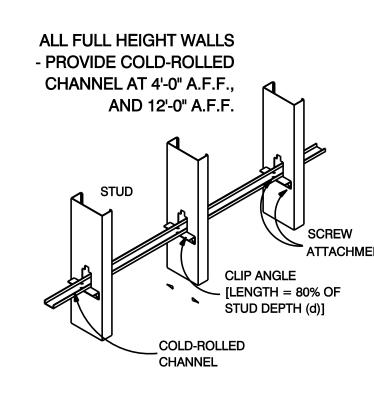




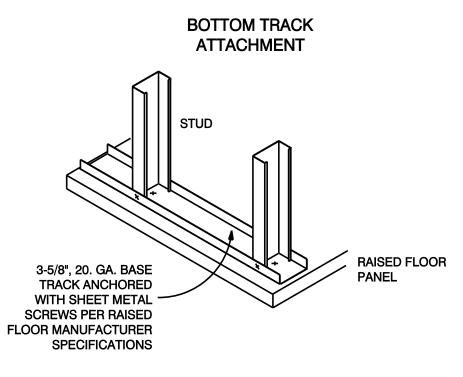




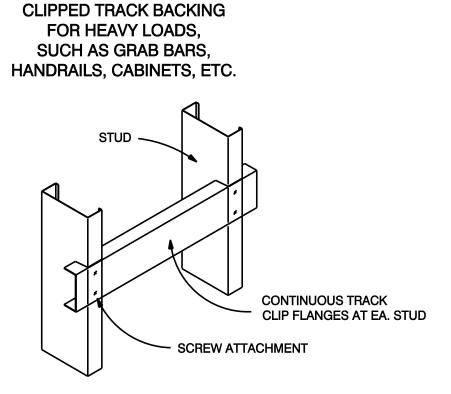

TRACK BACKING NOT TO SCALE

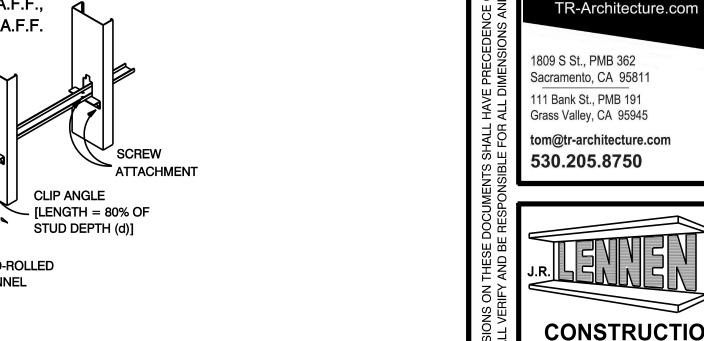


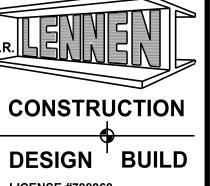

THOMAS ROMAN

Architecture

LICENSE #798968 STOCKTON: 209.933.9000 209.933.1900 FAX PALM DESERT: 760.636.5992 760.636.5996 FAX

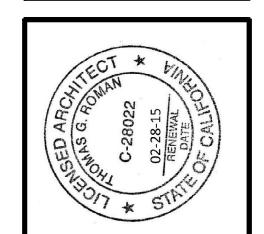

BANK

FINAL DRAWINGS


PERMIT SET 12-10-13

ALL FIELD CHANGES TO APPROVED SET OF PLANS SHALL BE FIRST APPROVED BY THE BUILDING DEPARTMENT. FAILURE TO PROVIDE CHANGES TO THE BUILDING DEPARTMENT WILL BE


CAUSE FOR THE DEPARTMENT TO ISSUE A STOP WORK NOTICE. CADD FOLDER BOS OAKDALE CADD FILE

DRAWN BY MISC. DETAILS




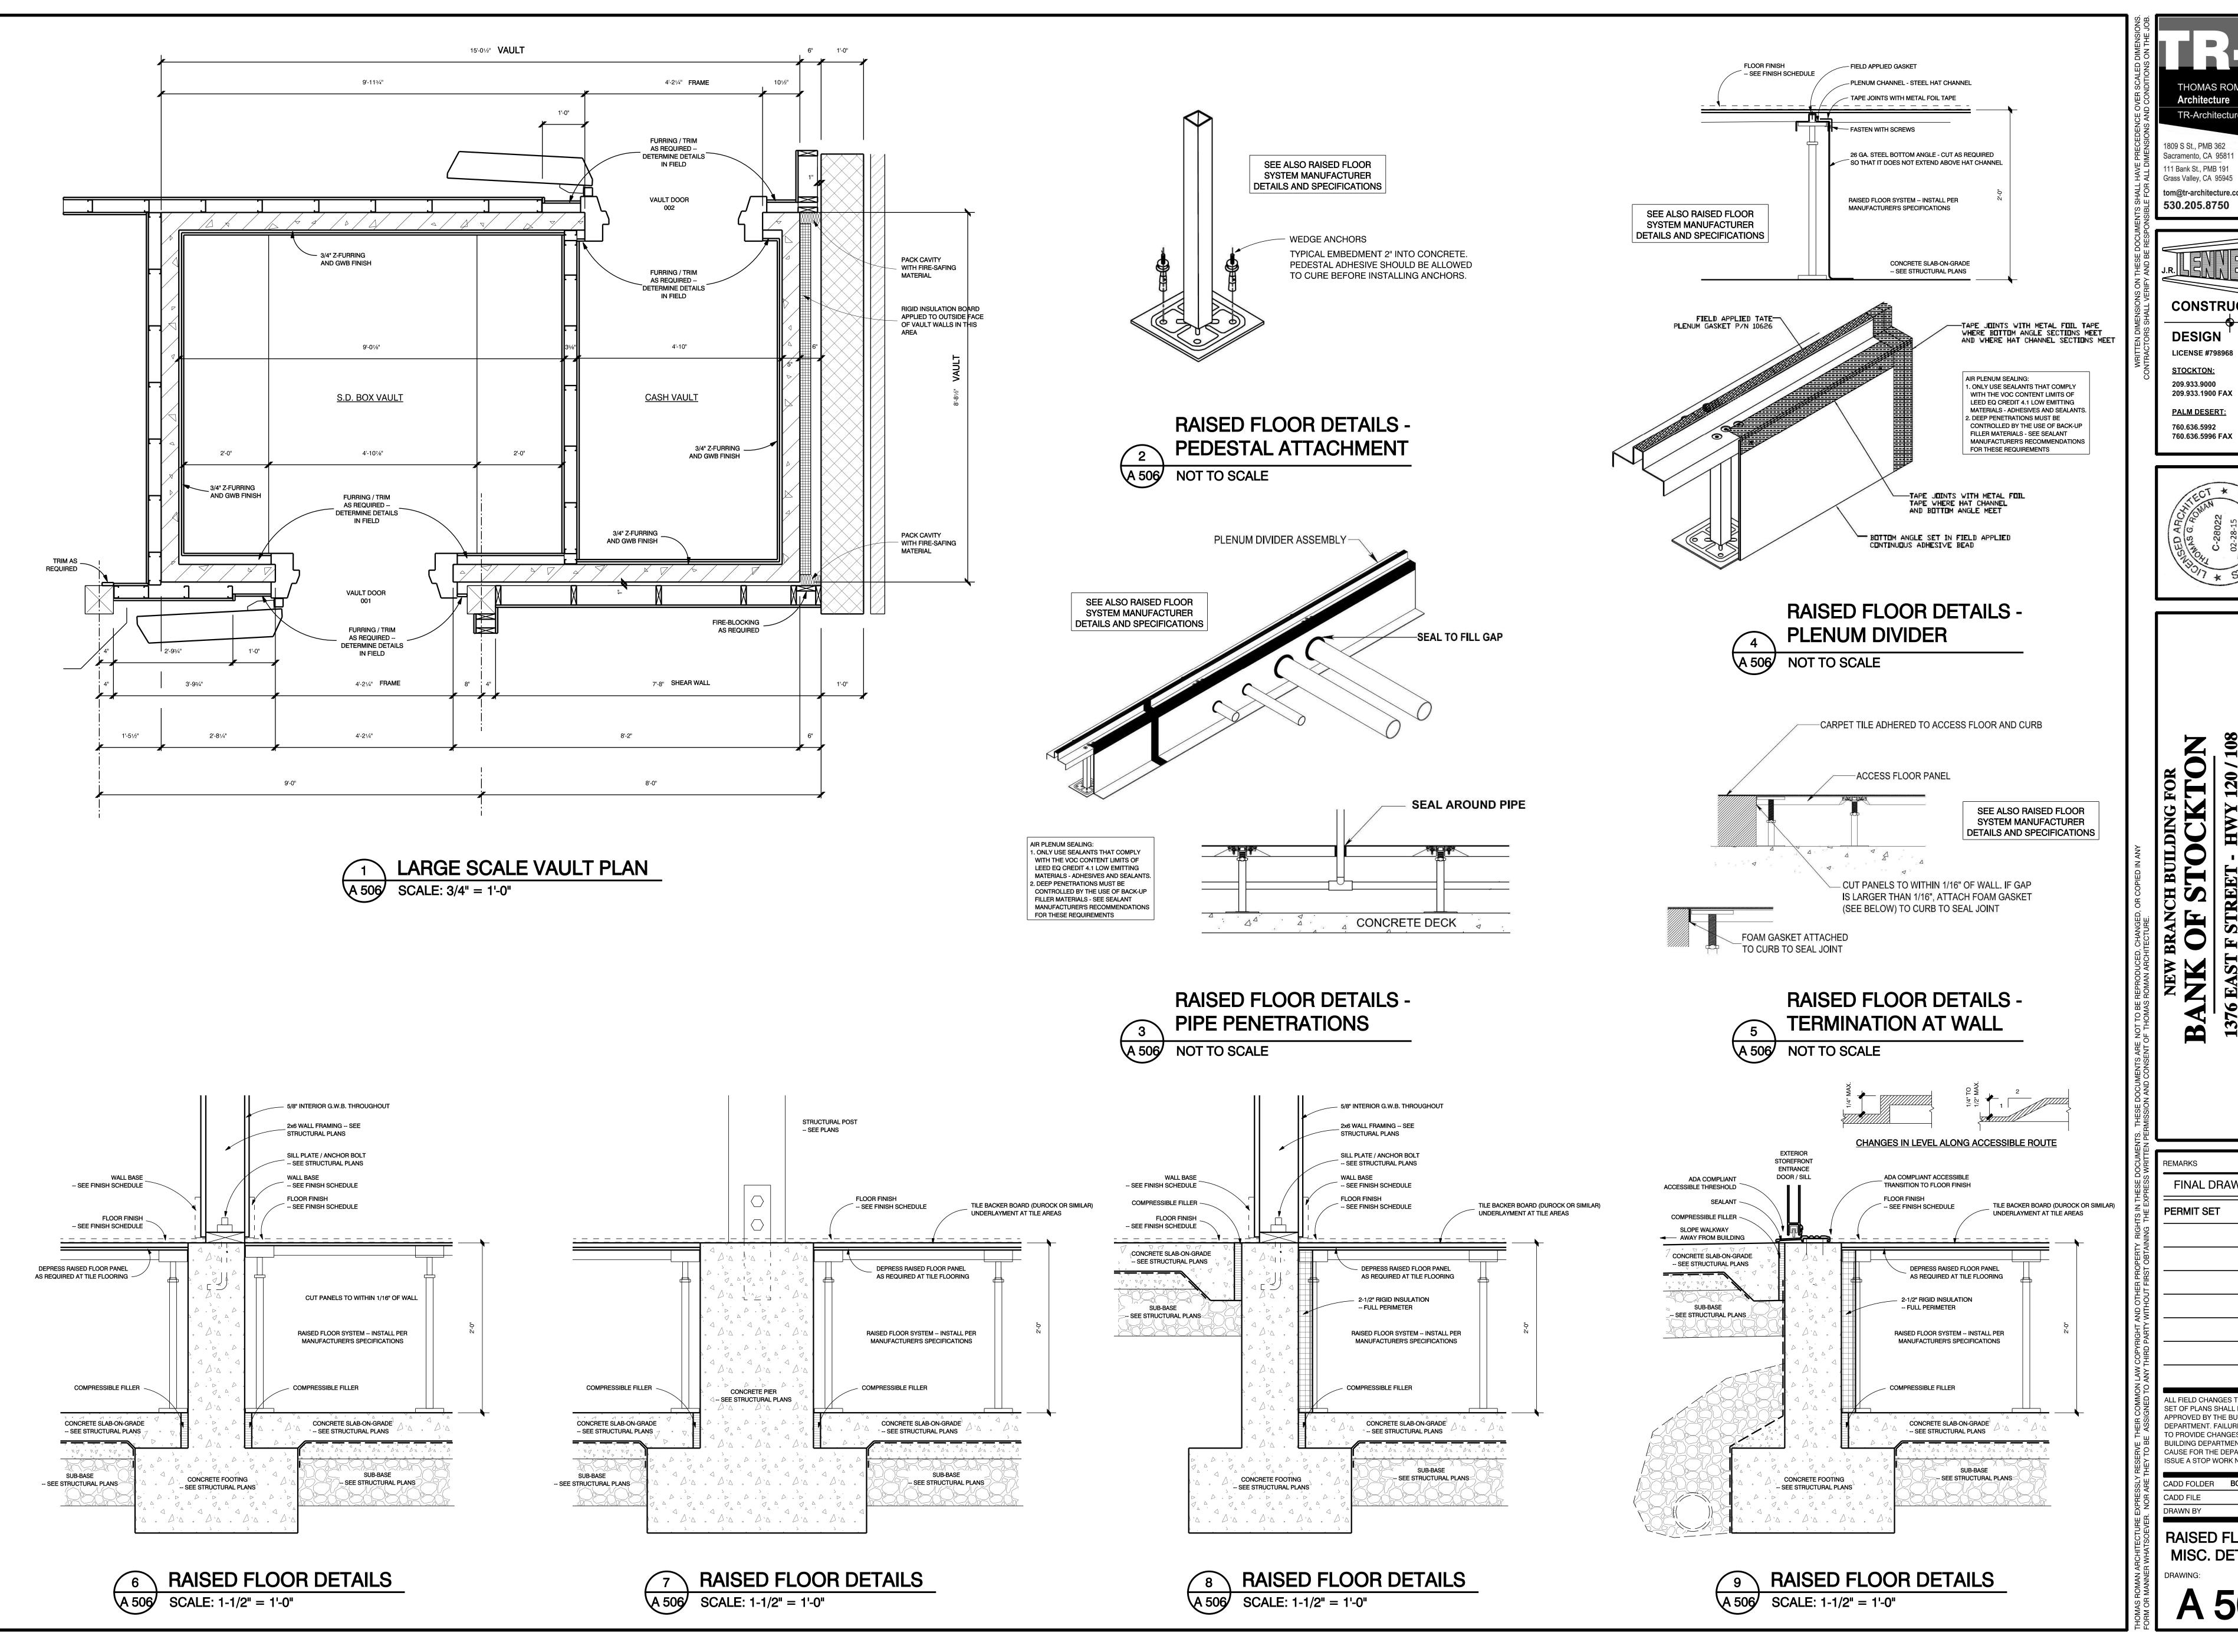

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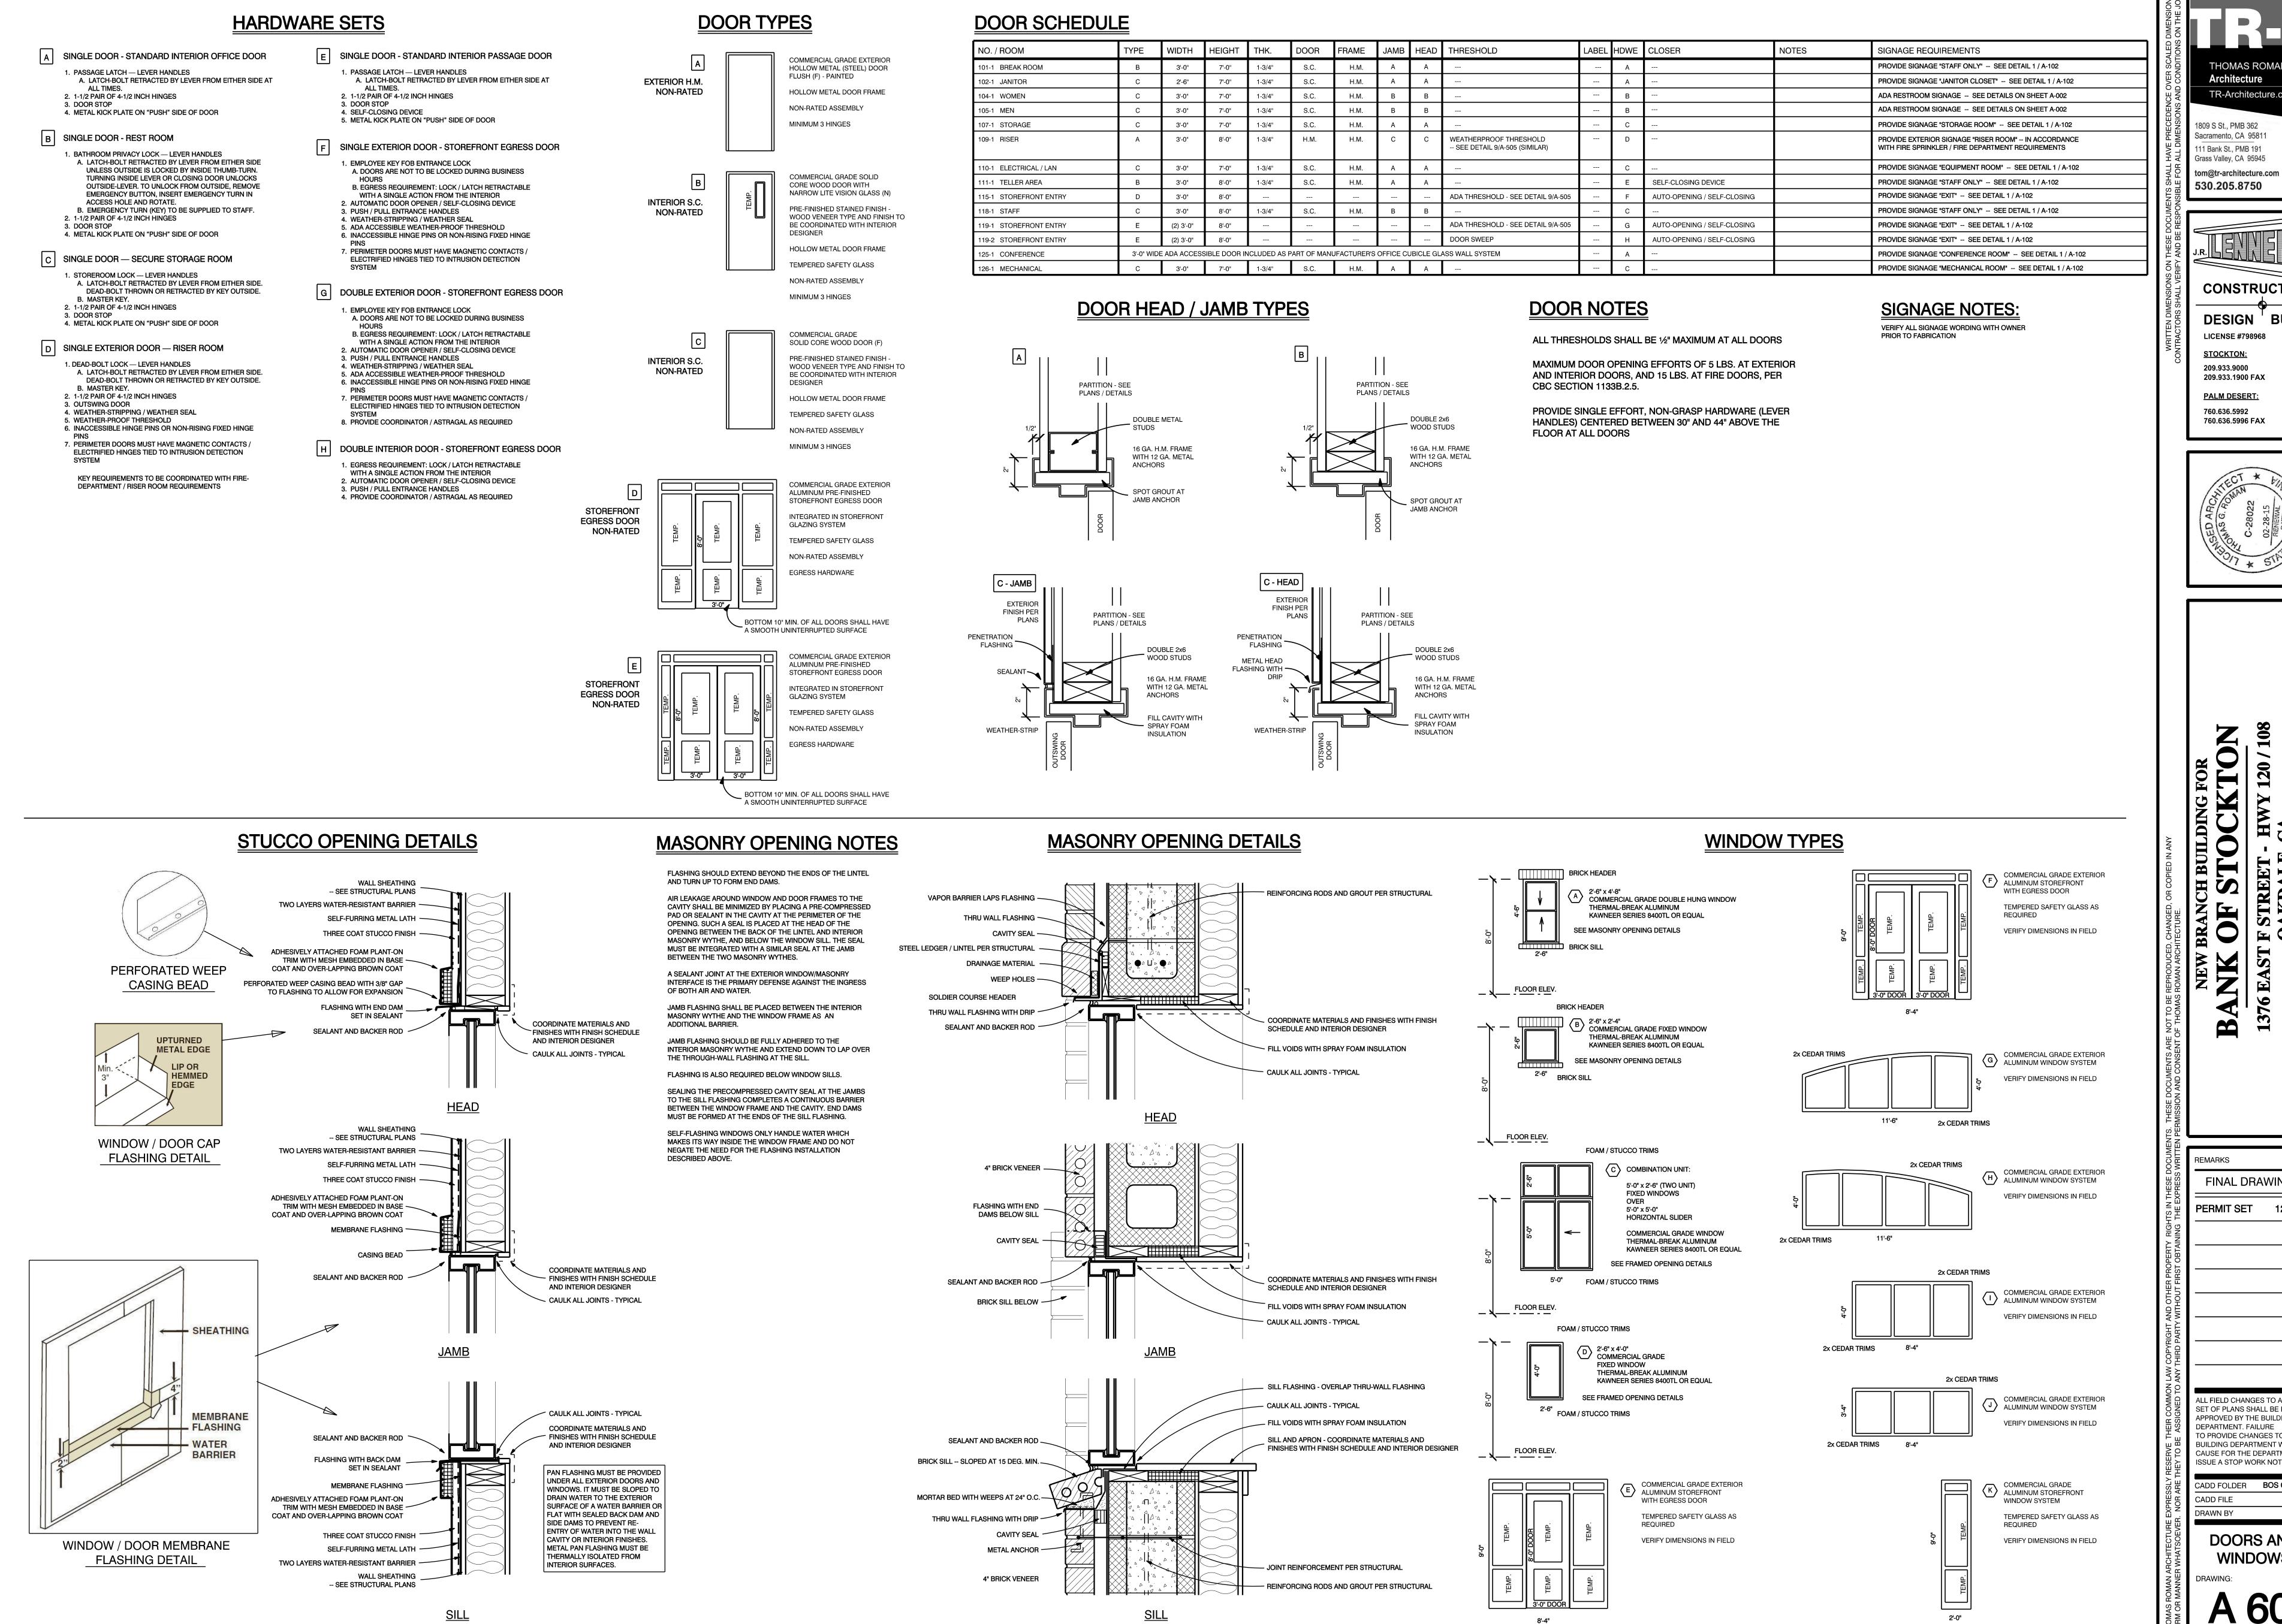

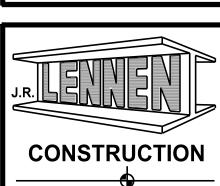
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CONSTRUCTION

DESIGN BUILD **LICENSE #798968**

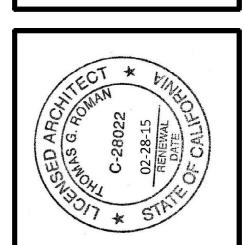PALM DESERT: 760.636.5996 FAX

FINAL DRAWINGS PERMIT SET 12-10-13

ALL FIELD CHANGES TO APPROVED SET OF PLANS SHALL BE FIRST APPROVED BY THE BUILDING TO PROVIDE CHANGES TO THE BUILDING DEPARTMENT WILL BE

CAUSE FOR THE DEPARTMENT TO ISSUE A STOP WORK NOTICE. CADD FOLDER BOS OAKDAL

DOORS AND WINDOWS

FINISH NOTES:

SEE CAL-GREEN REQUIREMENTS / NOTATIONS ON SHEET A-002

ALL BUILDING FINISHES SHALL BE FOR A FIRST CLASS, MODERN SPACE.

ALL FINISH MATERIALS SHALL BE SELECTED BY INTERIOR DESIGNER - CONTRACTOR SHALL SUBMIT COLOR AND FINISH MATERIAL SAMPLES (PLASTIC LAMINATE, PAINT, CARPET TILE,

INTERIOR DESIGNER PRIOR TO INSTALLATION.

MOISTURE RESISTANT G.W.B. (GREENBOARD) SHALL BE PROVIDED ON WALLS AT BATHROOMS, JANITOR CLOSET,

ETC.) TO BE USED FOR SELECTION AND APPROVAL TO

TILE BACKER BOARD SHALL BE USED AT ALL AREAS TO RECEIVE WALL TILE FINISHES

RISER ROOM AND AREAS SUBJECT TO MOISTURE.

FOAM PLASTICS SHALL NOT BE USED AS INTERIOR FINISH MATERIALS.

INTERIOR FINISHES SHALL BE AS PER "U.B.C. STANDARDS" AND C.B.C. CHAPTER 8.

MINIMUM OF CLASS III INTERIOR FINISHES, AS PER U.B.C. 802,

UNLESS OTHERWISE NOTED.

WALL AND CEILING MATERIALS SHALL NOT EXCEED THE FLAME SPREAD CLASSIFICATIONS IN CBC TABLE 8-B.

PAINTING:
UNLESS NOTED OTHERWISE ALL SURFACES TO BE PAINTED

SHALL RECEIVE A MINIMUM OF THREE (3) COATS.

WHERE FEASIBLE, REPROCESSED OR CONSOLIDATED LATEX PAINT WITH ZERO OR LOW V.O.C. SHALL BE USED IN ACCORDANCE WITH EPS'S CPG ON ALL PAINTED SURFACES. THE TYPE OF PAINT SHALL BE ACCEPTABLE TO THE THE OWNER'S REPRESENTATIVE AND THE INTERIOR DESIGNER. THE CONTRACTOR SHALL FOLLOW THE MANUFACTURER'S INSTRUCTIONS FOR THE APPLICATION AND MAINTENANCE OF ALL PAINT PRODUCTS.

ALL DOORS SHALL BE SOLID CORE WOOD WITH A NATURAL WOOD VENEER FACE OR AN EQUIVALENT PRE-APPROVED BY THE INTERIOR DESIGNER.

ALL DOORS SHALL BE PRIMED AND FINISHED WITH A LOW V.O.C. SEMI-GLOSS OIL BASED PAINT WITH NO FORMALDEHYDE.

THE CONTRACTOR SHALL CONSULT WITH THE INTERIOR DESIGNER PRIOR TO DEVELOPING A COLOR BOARD FOR ALL INTERIOR ELEMENTS SUCH AS PAINT, BASE COVING, CARPET, WINDOW TREATMENTS, LAMINATES, VINYL FLOORING, ETC. THE COLOR BOARD SHALL BE APPROVED BY THE INTERIOR DESIGNER PRIOR TO INSTALLATION. NO SUBSTITUTIONS

MAY BE MADE AFTER THE COLOR BOARD IS APPROVED.

WOOD PRODUCTS:

COLOR BOARD:

NEW INSTALLATIONS OF WOOD PRODUCTS USED UNDER THIS CONTRACT SHALL NOT CONTAIN WOOD FROM ENDANGERED WOOD SPECIES, AS LISTED BY THE CONVENTION ON INTERNATIONAL TRADE IN ENDANGERED SPECIES. THE LIST OF SPECIES CAN BE FOUND AT THE FOLLOWING WEB SITE: WWW.CERTIFIEDWOOD.ORG

PARTICLE BOARD, STRAWBOARD, AND PLYWOOD MATERIALS SHALL COMPLY WITH THE DEPARTMENT OF HOUSING AND URBAN DEVELOPMENT (HUD STANDARDS FOR FORMALDEHYDE EMISSION CONTROLS. PLYWOOD MATERIALS SHALL NOT EMIT FORMALDEHYDE IN EXCESS OF 0.2 PARTS PER MILLION (PPM), AND PARTICLE BOARD MATERIALS SHALL NOT EMIT FORMALDEHYDE IN EXCESS OF 0.3 PPM.

ADHESIVES AND SEALANTS:

ALL ADHESIVES EMPLOYED ON THIS PROJECT (INCLUDING BUT NOT LIMITED TO, ADHESIVES FOR CARPET, CARPET TILE, PLASTIC LAMINATE, WALL COVERINGS, ADHESIVES FOR WOOD, OR SEALANTS) SHALL BE THOSE WITH THE LOWEST POSSIBLE V.O.C. CONTENT BELOW 20 GRAMS PER LITER AND WHICH MEET THE REQUIREMENTS OF THE MANUFACTURER OF THE PRODUCTS ADHERED OR INVOLVED. THE CONTRACTOR SHALL USE ADHESIVES AND SEALANTS WITH NO FORMALDEHYDE OR HEAVY METALS.


ACOUSTIC INSULATION:


NO INSULATION INSTALLED WITH THIS PROJECT SHALL BE MATERIAL MANUFACTURED USING CHLOROFLUOROCARBONS (CFC'S), NOR SHALL CFC'S BE USED IN THE INSTALLATION OF THE PRODUCT.

FINISH SCHEDULE

COORDINATE ALL FINISHES WITH INTERIOR DESIGNER

ROOM	WALLS	CEILING	FLOORS	BASE	TRIM / ACCENTS	COMMENTS
101 BREAK ROOM	PAINTED GWB WALLS (HIGH QUALITY / WASHABLE SATIN)	PAINTED GWB CEILING (HIGH QUALITY / WASHABLE SATIN)	VINYL TILE FLOORING OVER RAISED FLOOR SYSTEM	4" VINYL BASE	GRANITE WINDOW SILL AND APRON TRIM, WITH DRYWALL WRAP AT JAMBS AND HEAD	KITCHENETTE BASE AND WALL CABINETS SEE CABINET SCHEDULE KITCHEN SINK AND APPLIANCES, WALL MOUNTED FLAT SCREEN TV, VIDEO SURVEILLANCE MONITOR SEE DETAIL 1 4603
102 JANITOR CLOSET	FRP PANEL WAINSCOT TO 54" (SEE DETAILS) WITH PAINTED GWB WALLS ABOVE (HIGH QUALITY / WASHABLE SATIN)	PAINTED GWB CEILING (HIGH QUALITY / WASHABLE SATIN)	VINYL TILE FLOORING OVER RAISED FLOOR SYSTEM	4" VINYL BASE		MOP SINK, MOP RACK, BUILT-IN SHELVING SEE DETAIL A602
103 HALL	PAINTED GWB WALLS (HIGH QUALITY / WASHABLE SATIN)	PAINTED GWB CEILING (HIGH QUALITY / WASHABLE SATIN)	CARPET TILE FLOORING OVER RAISED FLOOR SYSTEM	6" WOOD BASE - STAIN AND CLEAR COAT FINISH	GRANITE WINDOW SILL AND APRON TRIM, WITH DRYWALL WRAP AT JAMBS AND HEAD	
104 WOMEN'S TOILET ROOM	CERAMIC OR STONE TILE WAINSCOT TO 54" (SEE DETAILS) WITH PAINTED GWB WALLS ABOVE (HIGH QUALITY / WASHABLE SATIN)	PAINTED GWB CEILING (HIGH QUALITY / WASHABLE SATIN)	CERAMIC OR STONE TILE FLOORING OVER CONCRETE SLAB-ON-GRADE	CERAMIC OR STONE TILE COVE BASE	GRANITE WINDOW SILL AND APRON TRIM, WITH DRYWALL WRAP AT JAMBS AND HEAD	GRAB BARS, WALL MIRROR, TOILET ROOM ACCESSORIES SEE DETAILS 2 4602 4603
105 MEN'S TOILET ROOM	CERAMIC OR STONE TILE WAINSCOT TO 54" (SEE DETAILS) WITH PAINTED GWB WALLS ABOVE (HIGH QUALITY / WASHABLE SATIN)	PAINTED GWB CEILING (HIGH QUALITY / WASHABLE SATIN) EXPOSED BEAMS - STAIN AND CLEAR COAT FINISH	CERAMIC OR STONE TILE FLOORING OVER CONCRETE SLAB-ON-GRADE	CERAMIC OR STONE TILE COVE BASE		GRAB BARS, WALL MIRROR, TOILET ROOM ACCESSORIES SEE DETAILS SEE DETAILS SEE DETAILS
106 WORK AREA	PAINTED GWB WALLS (HIGH QUALITY / WASHABLE SATIN)	PAINTED GWB CEILING (HIGH QUALITY / WASHABLE SATIN)	CARPET TILE FLOORING OVER RAISED FLOOR SYSTEM	4" VINYL BASE	GRANITE WINDOW SILL AND APRON TRIM, WITH DRYWALL WRAP AT JAMBS AND HEAD	WORKSTATION BASE AND WALL CABINETS SEE CABINET SCHEDULE SEE DETAIL A603
107 STORAGE	PAINTED GWB WALLS (HIGH QUALITY / WASHABLE SATIN)	PAINTED GWB CEILING (HIGH QUALITY / WASHABLE SATIN)	VINYL TILE FLOORING OVER RAISED FLOOR SYSTEM	4" VINYL BASE		STORAGE SHELVING PROVIDED BY OWNER AND INSTALLED BY CONTRACTOR
108 HALL	PAINTED GWB WALLS (HIGH QUALITY / WASHABLE SATIN)	PAINTED GWB CEILING (HIGH QUALITY / WASHABLE SATIN)	CARPET TILE FLOORING OVER RAISED FLOOR SYSTEM	4" VINYL BASE	GRANITE WINDOW SILL AND APRON TRIM, WITH DRYWALL WRAP AT JAMBS AND HEAD	BULLETIN BOARDS, EMPLOYEE LOCKERS, SOLAR TUBE SKYLIGHTS
109 RISER	PAINTED GWB WALLS (HIGH QUALITY / WASHABLE SATIN)	PAINTED GWB CEILING (HIGH QUALITY / WASHABLE SATIN)	EXPOSED RAISED FLOOR SYSTEM	NONE		
110 ELECTRICAL / LAN	PLYWOOD SHEATHING THROUGHOUT - PAINTED	PAINTED GWB CEILING (HIGH QUALITY / WASHABLE SATIN)	EXPOSED RAISED FLOOR SYSTEM	NONE		ELECTRICAL AND COMPUTER EQUIPMENT
111 TELLER AREA	PAINTED GWB WALLS (HIGH QUALITY / WASHABLE SATIN)	PAINTED GWB CEILING (HIGH QUALITY / WASHABLE SATIN)	CARPET TILE FLOORING OVER RAISED FLOOR SYSTEM	6" WOOD BASE - STAIN AND CLEAR COAT FINISH		TELLER-LINE CASEWORK AND BACK-WALL CABINETS / COUNTER SEE CABINET SCHEDULE DISPLAY WALL, PNEUMATIC TUBE STATION SEE DETAILS 2 4603 4603
112 WORK AREA	PAINTED GWB WALLS (HIGH QUALITY / WASHABLE SATIN)	PAINTED GWB CEILING (HIGH QUALITY / WASHABLE SATIN)	CARPET TILE FLOORING OVER RAISED FLOOR SYSTEM	6" WOOD BASE - STAIN AND CLEAR COAT FINISH		ACCESSIBLE TELLER-LINE CASEWORK AND WORKSTATION BASE AND WALL CABINETS SEE CABINET SCHEDULE SEE DETAILS A603 A603
113 SAFE DEPOSIT VAULT	FURRING CHANNELS AND GWB OVER VAULT CONCRETE WALLS PAINTED (HIGH QUALITY / WASHABLE SATIN)	METAL FURRING / GWB CEILING UNDER VAULT CONSTRUCTION PAINTED (HIGH QUALITY / WASHABLE SATIN)	STONE TILE FLOORING OVER CONCRETE SLAB-ON-GRADE	STONE TILE BASE		SAFE DEPOSIT BOXES
114 CASH VAULT	FURRING CHANNELS AND GWB OVER VAULT CONCRETE WALLS PAINTED (HIGH QUALITY / WASHABLE SATIN)	METAL FURRING / GWB CEILING UNDER VAULT CONSTRUCTION PAINTED (HIGH QUALITY / WASHABLE SATIN)	STONE TILE FLOORING OVER CONCRETE SLAB-ON-GRADE	STONE TILE BASE		CASH VAULT
115 HOSPITALITY / COFFEE BAR	PAINTED GWB WALLS (HIGH QUALITY / WASHABLE SATIN)	NO CEILING / OPEN TO ABOVE EXPOSED BEAM / TRELLIS - STAIN AND CLEAR COAT FINISHES	STONE TILE FLOORING OVER RAISED FLOOR SYSTEM ENTRANCE MAT	STONE TILE BASE	EXPOSED WOOD POSTS, BEAMS AND TRIMS - STAIN AND CLEAR COAT FINISHES	COFFEE BAR AND DISPLAY CABINETS / COUNTER SEE CABINET SCHEDULE STOREFRONT CURTAIN WALL ENTRANCE, ARTWORK FEATURE WALL SEE DETAIL 5 4602
116 LOBBY	PAINTED GWB WALLS (HIGH QUALITY / WASHABLE SATIN)	HIGH CEILING WITH EXPOSED BEAMS / FRAMING AND WOOD VENEER FINISHES - STAIN AND CLEAR COAT FINISHES	STONE TILE FLOORING OVER RAISED FLOOR SYSTEM	STONE TILE BASE	EXPOSED WOOD POSTS, BEAMS AND TRIMS - STAIN AND CLEAR COAT FINISHES WOOD WINDOW CASING AND TRIMS AT CLERESTORY STAIN AND CLEAR COAT FINISHES	MARKETING DISPLAY CABINETS / COUNTER AND CHECKING COUNTER SEE CABINET SCHEDULE STOREFRONT CURTAIN WALL ENTRANCE, HIGH CLERESTORY WINDOWS, I-POD ON-LINE BANKING KIOSK SEE DETAIL 4602
117 VIEWING	PAINTED GWB WALLS (HIGH QUALITY / WASHABLE SATIN)	NO CEILING / OPEN TO ABOVE EXPOSED BEAM / TRELLIS - STAIN AND CLEAR COAT FINISHES	STONE TILE FLOORING OVER CONCRETE SLAB-ON-GRADE	STONE TILE BASE	EXPOSED WOOD POSTS, BEAMS AND TRIMS - STAIN AND CLEAR COAT FINISHES	VIEWING COUNTER SEE CABINET SCHEDULE HALF WALL WITH WOOD CAP - STAIN AND CLEAR COAT FINISH. STOREFRONT VIEW WINDOW. VAULT DOOR IS VISIBLE AND FEATURED
118 STAFF	PAINTED GWB WALLS (HIGH QUALITY / WASHABLE SATIN)	PAINTED GWB CEILING (HIGH QUALITY / WASHABLE SATIN)	VINYL TILE FLOORING OVER RAISED FLOOR SYSTEM	4" VINYL BASE		ATM AND NIGHT DROP ACCESS
119 VESTIBULE	PAINTED GWB WALLS (HIGH QUALITY / WASHABLE SATIN)	PAINTED GWB CEILING (HIGH QUALITY / WASHABLE SATIN) EXPOSED BEAMS - STAIN AND CLEAR COAT FINISH	STONE TILE FLOORING OVER CONCRETE SLAB-ON-GRADE RECESSED ENTRANCE MAT	STONE TILE BASE	EXPOSED WOOD POSTS, BEAMS AND TRIMS - STAIN AND CLEAR COAT FINISHES	STOREFRONT CURTAIN WALL ENTRANCES, DISPLAY NICHE SEE DETAIL 1 408
120 STAFF	PAINTED GWB WALLS (HIGH QUALITY / WASHABLE SATIN)	NO CEILING / OPEN TO ABOVE EXPOSED BEAM / TRELLIS - STAIN AND CLEAR COAT FINISHES	CARPET TILE FLOORING OVER RAISED FLOOR SYSTEM	6" WOOD BASE - STAIN AND CLEAR COAT FINISH	FULL WOOD CASING / SILL / RETURNS / TRIMS AT WINDOW STAIN AND CLEAR COAT FINISH EXPOSED WOOD POSTS, BEAMS AND TRIMS - STAIN AND CLEAR COAT FINISHES	WORKSTATION BASE AND UPPER CABINETS SEE CABINET SCHEDULE CAP WALLS WITH WOOD CAP - STAIN AND CLEAR COAT FINISH. COPIER / PRINTER BY OWNER. FILE CABINETS BY OWNER SEE DETAIL 1 4603
121 WAITING AREA	PAINTED GWB WALLS (HIGH QUALITY / WASHABLE SATIN)	PAINTED GWB CEILING (HIGH QUALITY / WASHABLE SATIN)	CARPET TILE FLOORING OVER RAISED FLOOR SYSTEM	6" WOOD BASE - STAIN AND CLEAR COAT FINISH	EXPOSED WOOD POSTS, BEAMS AND TRIMS - STAIN AND CLEAR COAT FINISHES	COMMUNITY DISPLAY COUNTER SEE CABINET SCHEDULE WALL MOUNTED TOUCH SCREEN INTERACTIVE TV DISPLAY SYSTEM SEE DETAIL 5 4602
122 CONSULTATION #1	PAINTED GWB WALLS (HIGH QUALITY / WASHABLE SATIN)	PAINTED GWB CEILING (HIGH QUALITY / WASHABLE SATIN) PARTIAL EXPOSED BEAM / TRELLIS - STAIN AND CLEAR COAT	CARPET TILE FLOORING OVER RAISED FLOOR SYSTEM	6" WOOD BASE - STAIN AND CLEAR COAT FINISH	FULL WOOD CASING / SILL / RETURNS / TRIMS AT WINDOW STAIN AND CLEAR COAT FINISH	OFFICE CUBICLE GLASS WALL SYSTEM
123 CONSULTATION #2	PAINTED GWB WALLS (HIGH QUALITY / WASHABLE SATIN)	PAINTED GWB CEILING (HIGH QUALITY / WASHABLE SATIN)	CARPET TILE FLOORING OVER RAISED FLOOR SYSTEM	6" WOOD BASE - STAIN AND CLEAR COAT FINISH	FULL WOOD CASING / SILL / RETURNS / TRIMS AT WINDOW STAIN AND CLEAR COAT FINISH	OFFICE CUBICLE GLASS WALL SYSTEM
124 CONSULTATION #3	PAINTED GWB WALLS (HIGH QUALITY / WASHABLE SATIN)	PAINTED GWB CEILING (HIGH QUALITY / WASHABLE SATIN)	CARPET TILE FLOORING OVER RAISED FLOOR SYSTEM	6" WOOD BASE - STAIN AND CLEAR COAT FINISH	FULL WOOD CASING / SILL / RETURNS / TRIMS AT WINDOW STAIN AND CLEAR COAT FINISH	OFFICE CUBICLE GLASS WALL SYSTEM
125 CONFERENCE ROOM	PAINTED GWB WALLS (HIGH QUALITY / WASHABLE SATIN)	PAINTED GWB CEILING (HIGH QUALITY / WASHABLE SATIN) PARTIAL EXPOSED BEAM / TRELLIS - STAIN AND CLEAR COAT	CARPET TILE FLOORING OVER RAISED FLOOR SYSTEM	6" WOOD BASE - STAIN AND CLEAR COAT FINISH	FULL WOOD CASING / SILL / RETURNS / TRIMS AT WINDOW STAIN AND CLEAR COAT FINISH	KITCHENETTE BASE AND WALL CABINETS SEE CABINET SCHEDULE KITCHEN SINK AND APPLIANCES, ROLL DOWN SCREEN, A/V CABINET WITH WHITE BOARD, CEILING MOUNTED PROJECTOR, OFFICE CUBICLE GLASS WALL SYSTEM TO UNDERSIDE OF CEILING
110 MECHANICAL	PAINTED GWB WALLS (HIGH QUALITY / WASHABLE SATIN)	PAINTED GWB CEILING (HIGH QUALITY / WASHABLE SATIN)	EXPOSED RAISED FLOOR SYSTEM	NONE		MECHANICAL EQUIPMENT

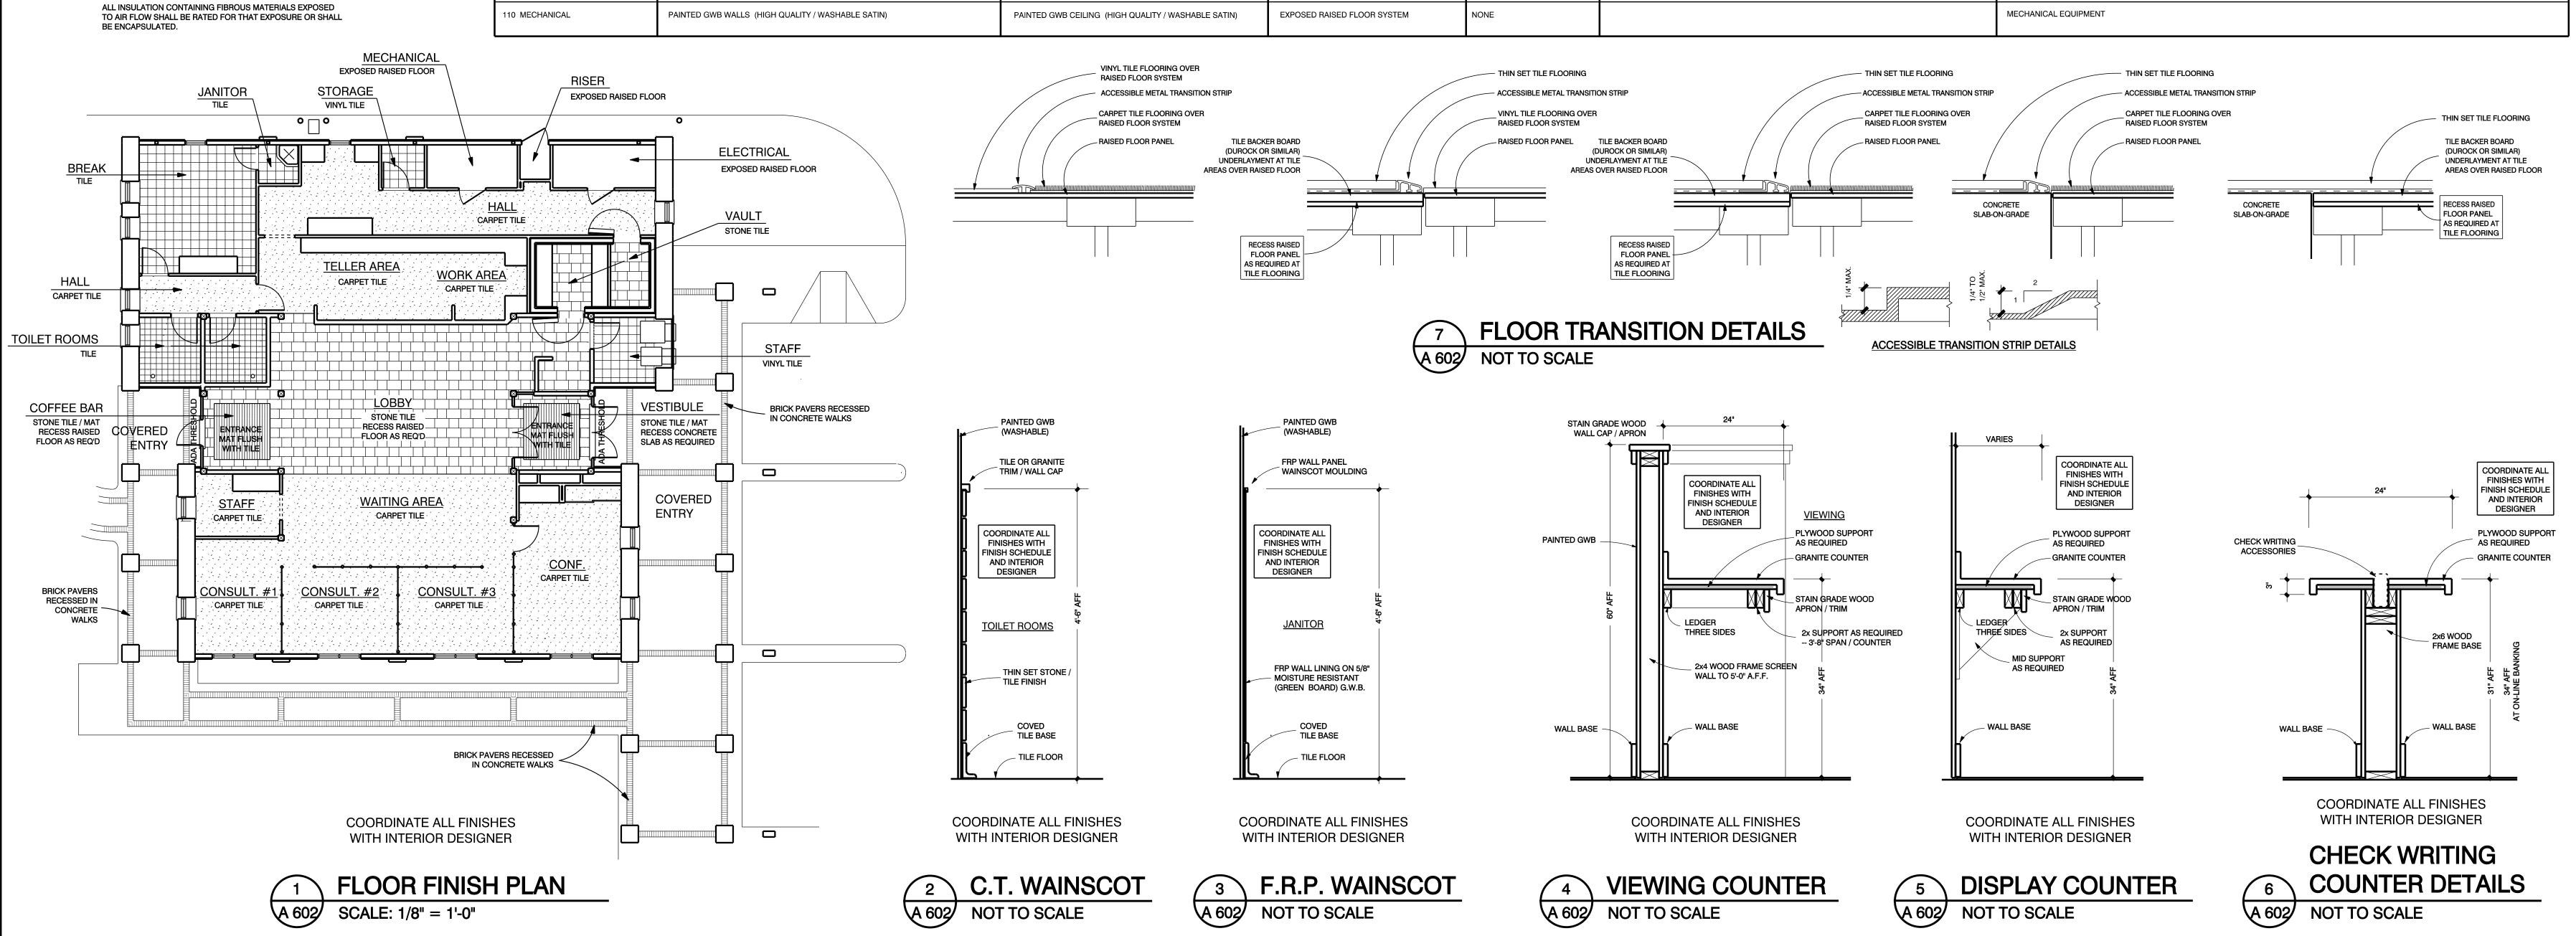

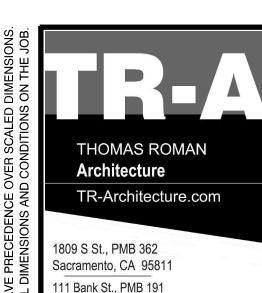

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530.205.8750

CONSTRUCTION

DESIGN BUILD

LICENSE #798968


STOCKTON:
209.933.9000

209.933.1900 FAX

PALM DESERT:

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760.636.5996 FAX

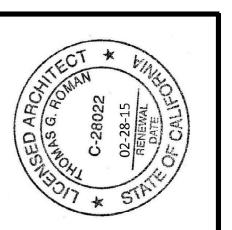

STATE STATE

BANK OF STOCKTO

1376 EAST F STREET - HWY 120 / 1
OAKDALE, CA.

REMARKS

DATE

FINAL DRAWINGS

FINAL DRAWINGS


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12-10-13

ALL FIELD CHANGES TO APPROVED SET OF PLANS SHALL BE FIRST APPROVED BY THE BUILDING DEPARTMENT. FAILURE TO PROVIDE CHANGES TO THE BUILDING DEPARTMENT WILL BE CAUSE FOR THE DEPARTMENT TO ISSUE A STOP WORK NOTICE.

CADD FOLDER BOS OAKDALI
CADD FILE A 6-2
DRAWN BY TF

FINISHES / INTERIORS

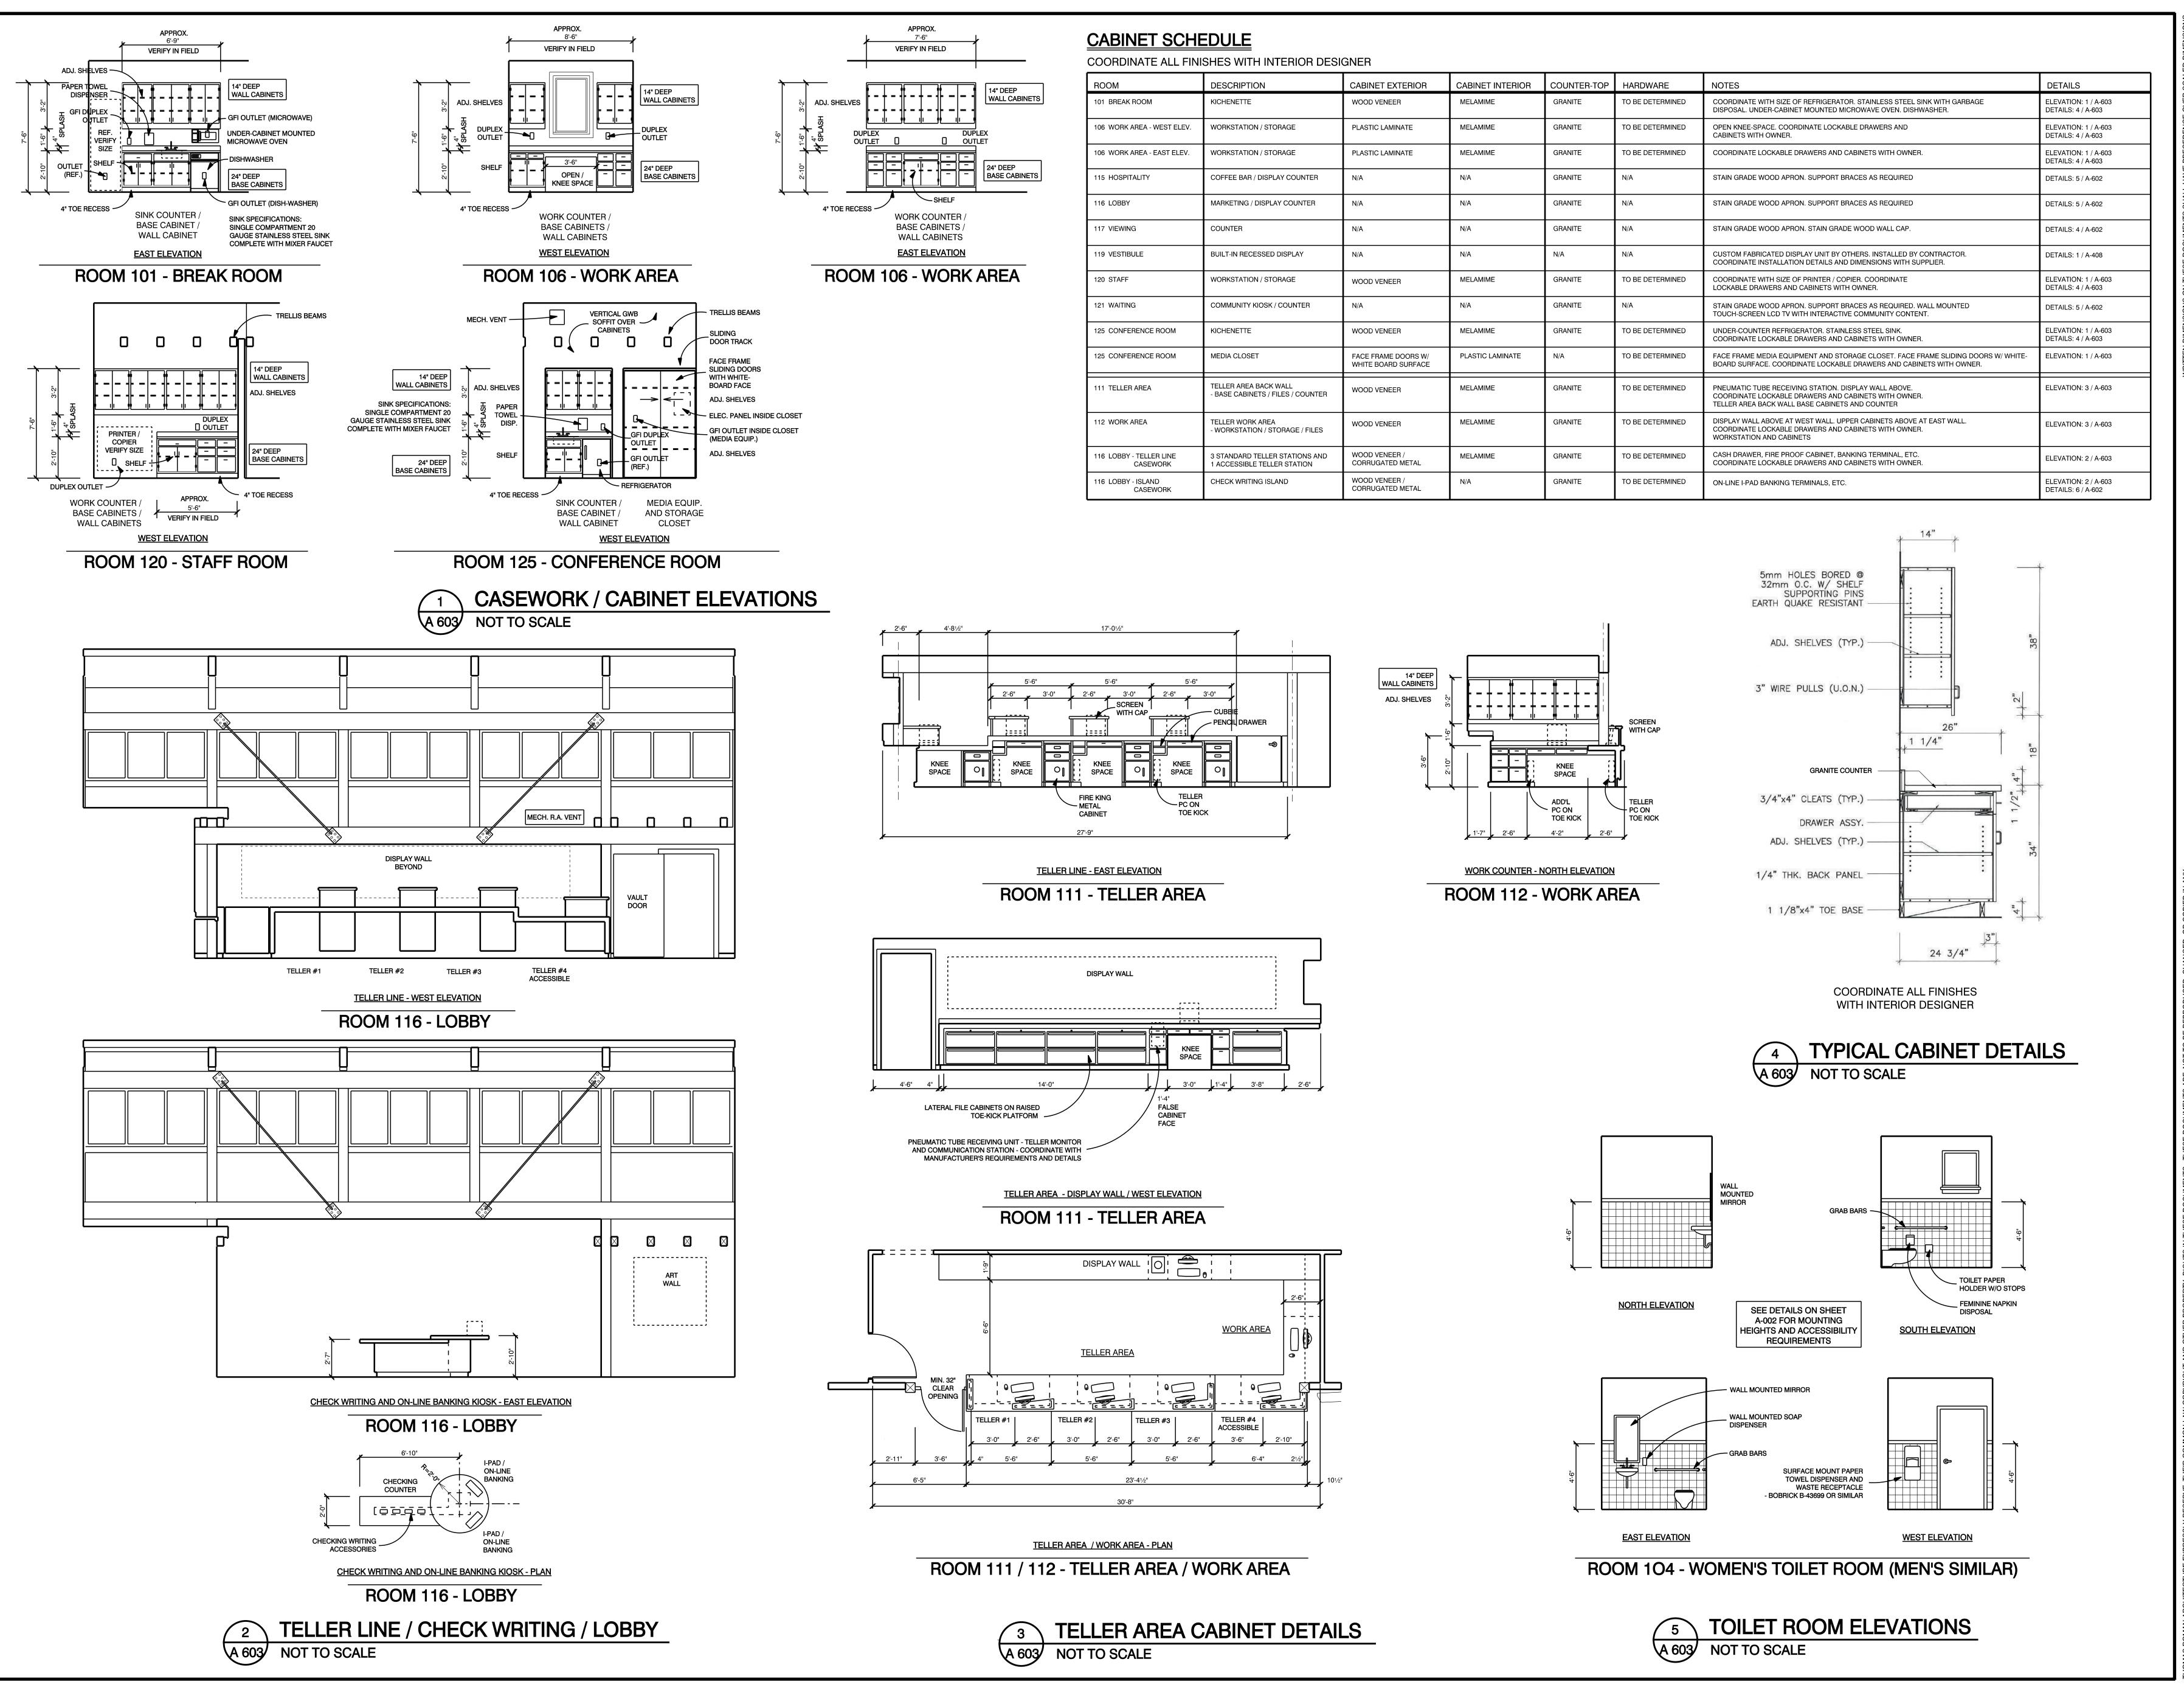


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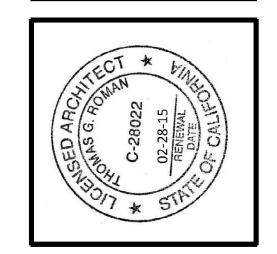
CONSTRUCTION

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STOCKTON:



BUILDING FOR TOCKTON
ET - HWY 120 / 108
ALE, CA.

BANK OF STOCKT

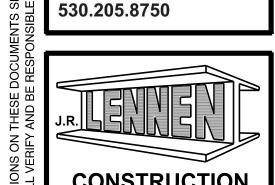1376 EAST F STREET - HWY 12


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CADD FOLDER BOS OAKDALE
CADD FILE A 6-3
DRAWN BY TF

CABINETS / INTERIORS



COORDINATE LOCATION WITH SITE PLANS

CMU > 6" TALL RAISED CONCRETE CURB 6" CONCRETE PAD SLOPE PAVING - SLOPE NOT TO EXCEED 2% 6" DIA. CONCRETE **SECTION** FILLED METAL POST JOINT IN CONCRETE - PAINTED 6" CONCRETE PAD
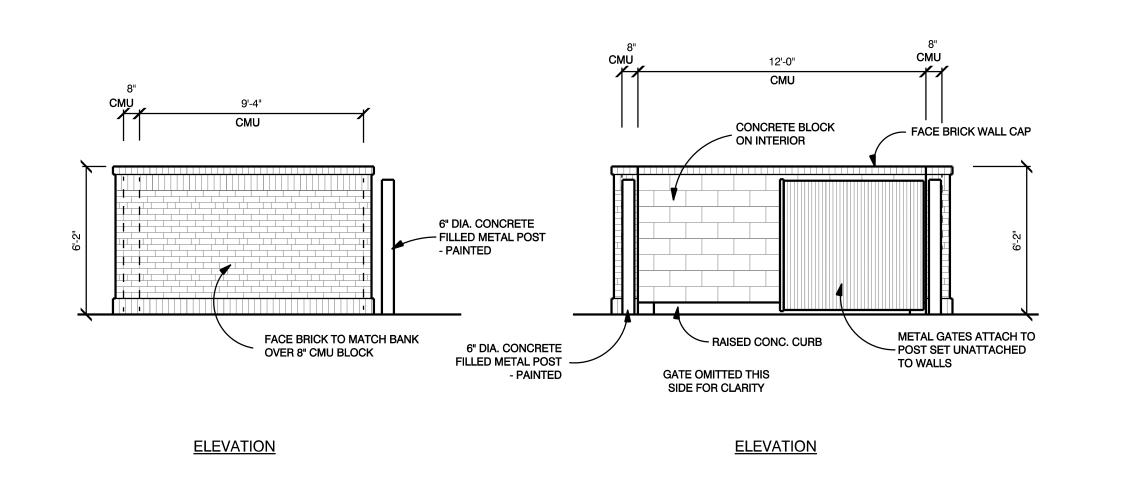
<u>PLAN</u>

14'-0" CMU CAST METAL LETTERS APPROX. 12" HIGH **BANK OF STOCKTON** MONUMENT SIGN: 3'-6" x 14'-8" = 52 SQ. FT. LIGHTING r -'-'- ŋ L _ _ _ J L _ _ _ _ _ _ J **BOTH SIDES BOTH ENDS**


FACE BRICK TO MATCH BANK

OVER 8" CMU BLOCK

14'-8"


COORDINATE LOCATION WITH SITE PLANS

MONUMENT SIGNAGE ELEVATIONS SCALE: 1/4" = 1'-0"

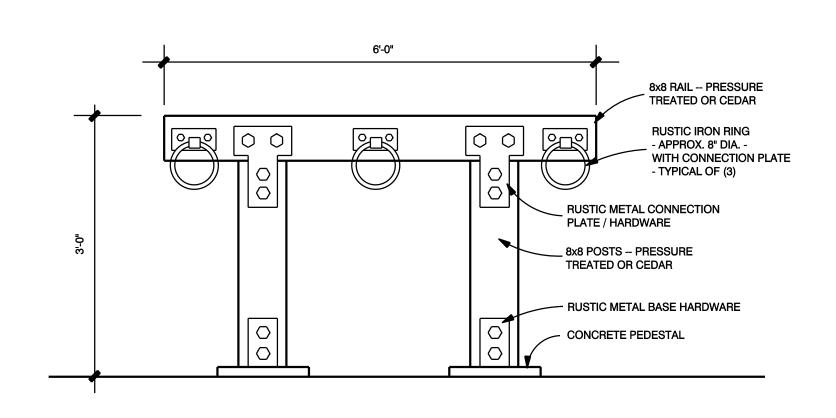


COORDINATE LOCATION WITH SITE PLANS



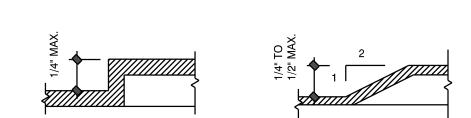

CHANGES IN LEVEL ALONG ACCESSIBLE ROUTE

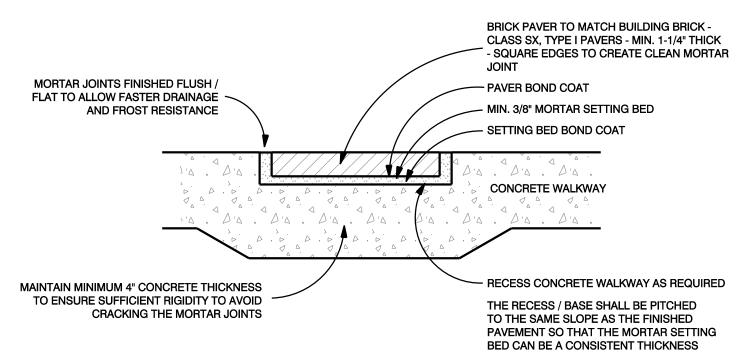

BRICK PAVER DETAILS

BONDED SYSTEM: IN BONDED SYSTEMS, THE CLAY PAVERS ARE ADHERED TO


THE MORTAR SETTING BED, WHICH IS IN TURN ADHERED TO THE UNDERLYING CONCRETE BASE. WHEN THE BASE MOVES, SO WILL THE PAVERS, AND VICE VERSA. AS SUCH, IT IS ESSENTIAL THAT ALL MOVEMENT JOINTS ARE CARRIED THROUGH THE CONCRETE BASE, THE MORTAR SETTING BED AND THE PAVERS. THE LOCATION AND DESIGN OF MOVEMENT JOINTS SHOULD TAKE INTO ACCOUNT THE EXPANSION AND CONTRACTION PROPERTIES OF EACH OF THE PAVEMENT LAYERS, AS THEY WILL BE SUBJECT TO VARIOUS TEMPERATURE AND MOISTURE CONDITIONS. MOVEMENT
JOINTS IN A CONCRETE BASE SHOULD ALIGN WITH THE PAVER EXPANSION JOINT SPACING. MORTAR SETTING BEDS IN BONDED SYSTEMS ARE USUALLY BETWEEN 3/4 AND 11/2 IN.

MOVEMENT JOINTS:

MOVEMENT JOINT SPACING IN THE BRICK PAVING SURFACE SHOULD NOT EXCEED 16 FT IN ANY DIRECTION. MOVEMENT JOINTS SHOULD PENETRATE THE SETTING BED AND THE PAVERS. IN A BONDED SYSTEM, THEY SHOULD BE ALIGNED DIRECTLY OVER THE UNDERLYING JOINTS IN THE CONCRETE. THE MOVEMENT JOINTS SHOULD CONSIST OF COMPRESSIBLE JOINT FILLER, DE-BONDING STRIP AND JOINT SEALANT. MOVEMENT JOINT WIDTH SHOULD BE BASED UPON THE MOVEMENT POTENTIAL OF THE JOINT AND THE TYPE OF SEALANT MATERIAL USED. MANUFACTURERS' DETAILS SHOULD BE CONSULTED FOR SEALANT PROPERTIES.

NOT TO SCALE




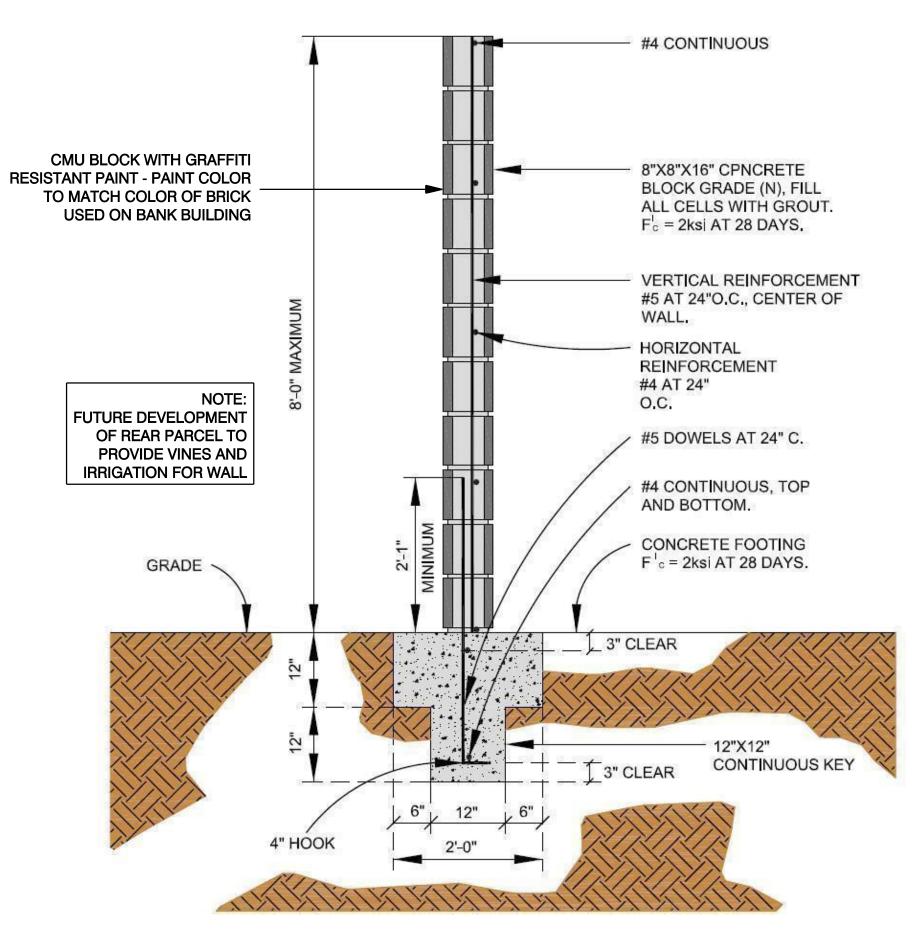

C.M.U. WALL MATERIALS AND CONSTRUCTION TO BE IN ACCORDANCE WITH CITY OF OAKDALE BUILDING DEPARTMENT STANDARDS FOR 8 FT. MASONRY FENCE WALL

> COORDINATE LOCATION WITH SITE PLANS

3 SITE WALL DETAILS
A 701 NOT TO SCALE

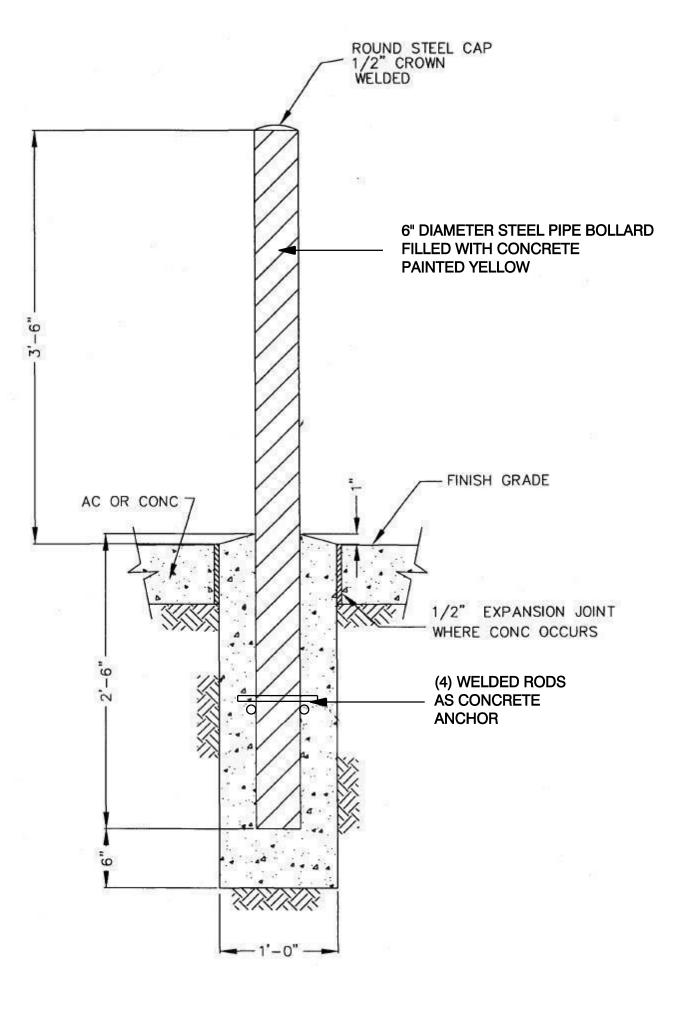


VERIFY LOCATIONS IN FIELD

A 701 NOT TO SCALE

STEEL BOLLARD DETAILS






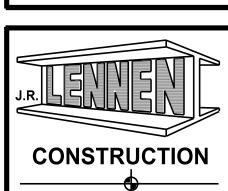

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FINAL DRAWINGS

PERMIT SET 12-10-13
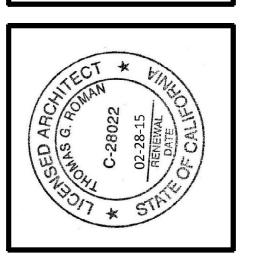
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SITE ITEMS